# PRELIMINARY AND FINAL SITE PLAN

FOR



PROPOSED AUTOZONE RETAIL STORE

**AUTOZONE STORE #3644** 

BLOCK 6.07, LOT 14.02, TAX MAP SHEET #9

40-50 PRINCETON-HIGHTSTOWN ROAD

TOWNSHIP OF EAST WINDSOR, MERCER COUNTY, NEW JERSEY

## LIST OF PROPERTY OWNERS WITHIN 200 FEET:

14.01 EAST WINDSOR TOWNSHIP 16 LANNING BLVD EAST WINDSOR, NJ 08520 6.07 14.04 KIR EAST WINDSOR, LLC 500 NORTH BROADWAY, #201 JERICHO, NY 11753

6.07 15 CADUNER FAMILY LP, I D01 18 PRINCETON-HIGHTST RD EAST WINDSOR, NJ 08520 CADUNER FAMILY LP, I

BLOCK LOT(S) OWNER/ADDRESS

D02 18 PRINCETON-HIGHTST RD EAST WINDSOR, NJ 08520

> R.A.WAGNER 175 WEST MAIN ST FREEHOLD, NJ 07728

COMCAST CABLEVISION GENERAL MANAGER P.O. BOX 790, 90 LAKE DR EAST WINDSOR, NJ 08520

DEPARTMENT OF TRANSPORTATION STATE OF NEW JERSEY 1035 PARKWAY AVE TRENTON, NJ 08650

EAST WINDSOR UTILITIES AUTHORITY MR.TOD FRYER, GENERAL MANAGER 7 WILTSHIRE OR EAST WINDSOR, NJ 08520

JCP&L C/O GPU ENERGY CORPORATE SECRETARY 300 MADISON AVE

MORRISTOWN, NJ 07962

MERCER COUNTY PLANNING BOARD ADMINISTRATION BLDG.

BLOCK LOT(S) OWNER/ADDRESS

SHIVAM HOLDING, LLC

209 MOUNTAIN PKWY

209 MOUNTAIN PKWY

CARLSBAD, CA 92018

MANHASSET, NY 11030

42 BAYVIEW AVE

GREEN BROOK, NJ 08812

GREEN BROOK, NJ 08812

STATEN ISLAND, NY 10312

HIWELL LIMITED LIABILITY COMPANY

HIWELL LIMITED LIABILITY COMPANY

NJ NAT. BANK C/O THOMPSON REUTERS

WINDSOR CORNER, LLC C/O MILLBROOK

89 JARVIS AVE

CORPORATE SECRETARY P.O. BOX 800 NEWARK, NJ 07101

TRENTON, NJ 08650-8068

TRANSCONTINENTAL GAS PIPE LINE CORP DISTRICT MANAGER 3200 SOUTH WOOD AVE LINDEN, NJ 07036-0005

CORPORATE SECRETARY 540 BROAD STREET NEWARK, NJ 07101

#### GRAPHIC SCALE ( IN FEET ) 1 inch = 500 ft.

**AERIAL MAP** 

SCALE: 1"=500'

OWNER:

ROBERT J. NASUT C/O: SUMMERWODD CORP. 14 BALLIGOMINGO ROAD, P.O. BOX 429 CONSHOHOCKEN, PA 19428


APPLICANT:

AUTOZONE, NORTHEAST, LLC. C/O: DAVID BENTLEY 123 S. FRONT STREET, 3rd FLOOR MEMPHIS, TENNESSEE 38103 (901) 495-8729

ATTORNEY:

FRANCIS J. DEVITO ATTORNEYS AT LAW OF N.J. AND N.Y. 250 MOONACHIE ROAD, SUITE 305 MOONACHIE, NEW JERSEY 07074 (201) 487-7575

**KEY MAP** 

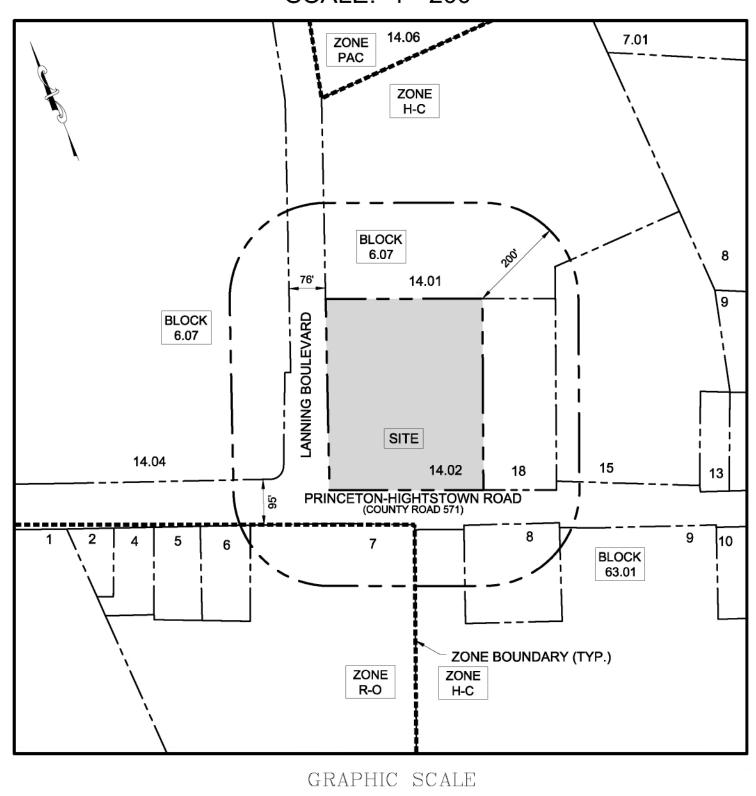

( IN FEET ) 1 inch = 200 ft.

ARCHITECT:

AUTOZONE, NORTHEAST, LLC. C/O: LEW ELLIS 123 S. FRONT STREET, 3rd FLOOR MEMPHIS, TENNESSEE 38103 (901) 495-8600

PLAN SUBMITTAL DATE: 7/20/22

NORTH STAR DESIGN, LLC C/O: THOMAS F. PUGSLEY, JR. 361 ROUTE 31, BLDG E, SUITE 1404 FLEMINGTON, NEW JERSEY 08822 (908) 968-3499

CIVIL ENGINEER:

## LIST OF AGENGY APPROVALS

TOWNSHIP OF EAST WINDS	SOR PLANNING BOARD
MERCER COUNTY PLANNIN	G BOARD
MERCER COUNTY SOIL CON	ISERVATION DISTRICT
DELAWARE & RARITAN CAN	NAL COMMISSION

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## APPROVAL BLOCK

APPROVED BY THE EAST WINDSOR TOW MERCER COUNTY, NEW JERSEY	NSHIP PLANNING BOARD,
BOARD CHAIRPERSON	DATE
BOARD SECRETARY	DATE



REV.	REV. DATE:	REVISION COMMENT:	BY:
1	11/10/22	REV. PER DRAINAGE CALCS	$_{ m CM}$

NJ LICENSE No.43527

SHEET TITLE:

PRE

COVER **SHEET** 


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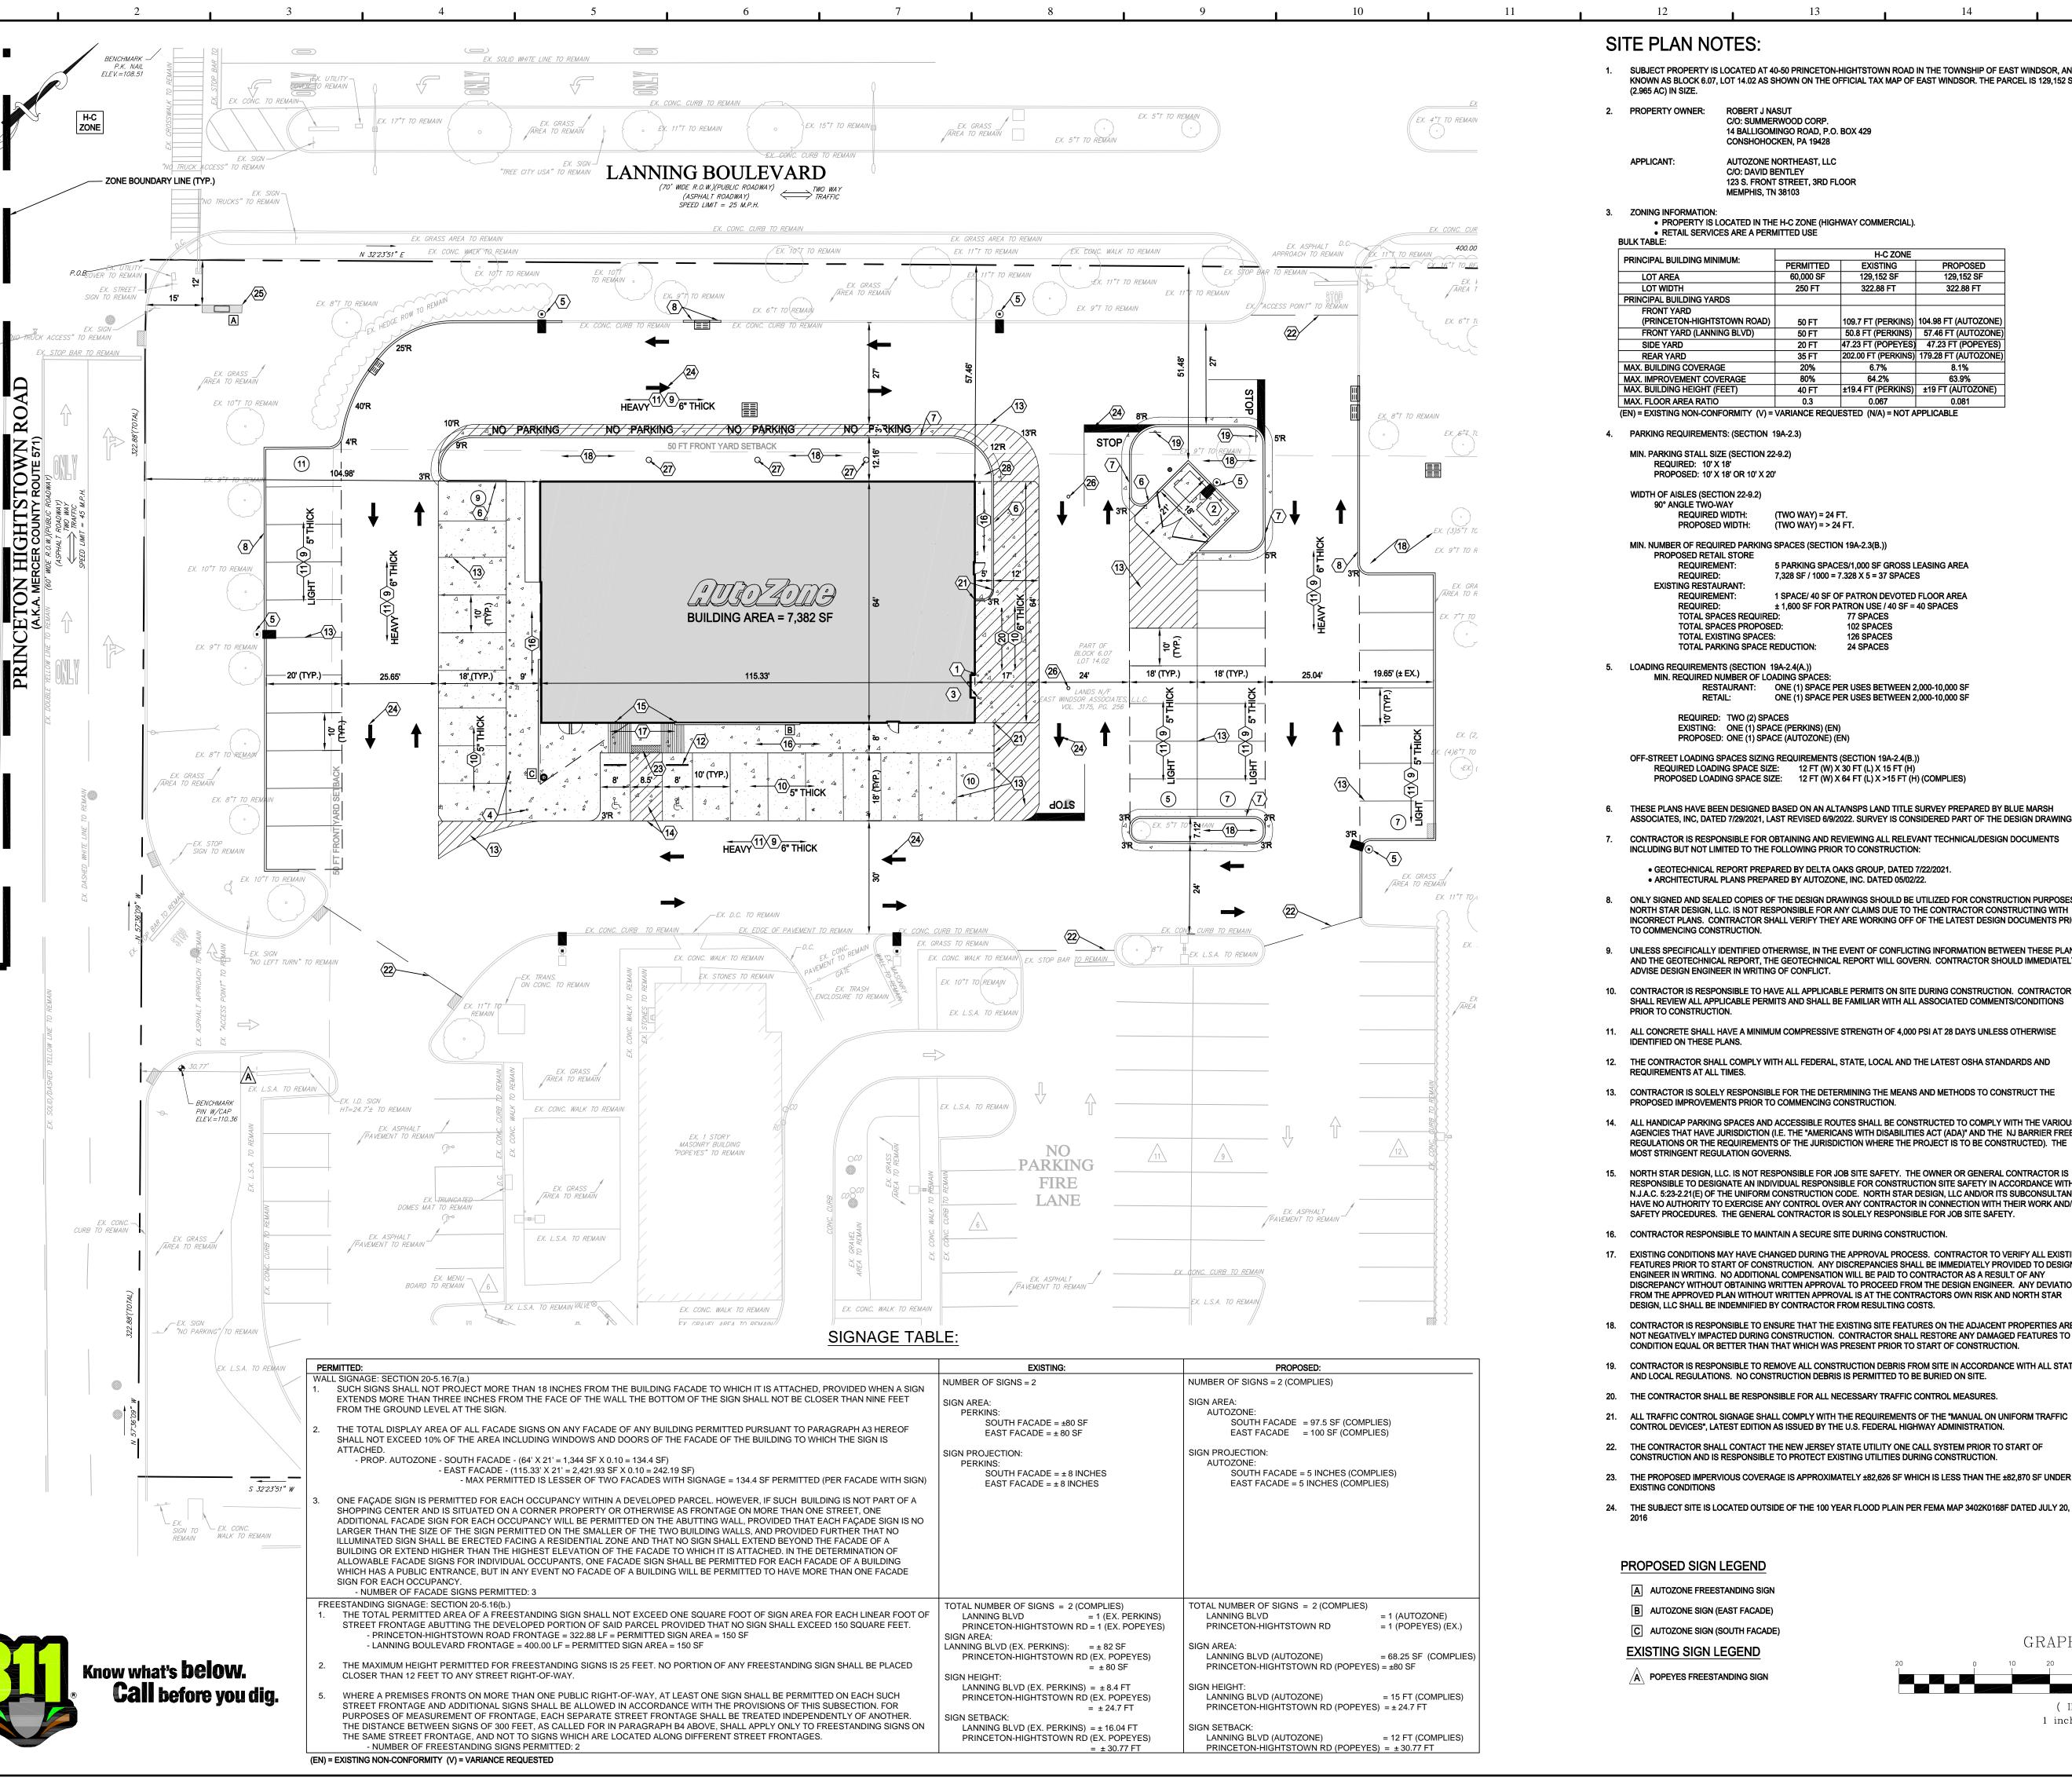
**DESIGNED BY:** CHECKED BY: PROJECT #: CAD FILE:

**REVISION 1** 

DRAWING SCALE: As Shown 21-020CS01 ZONING DISTRIC H-C ZONE

11/10/22



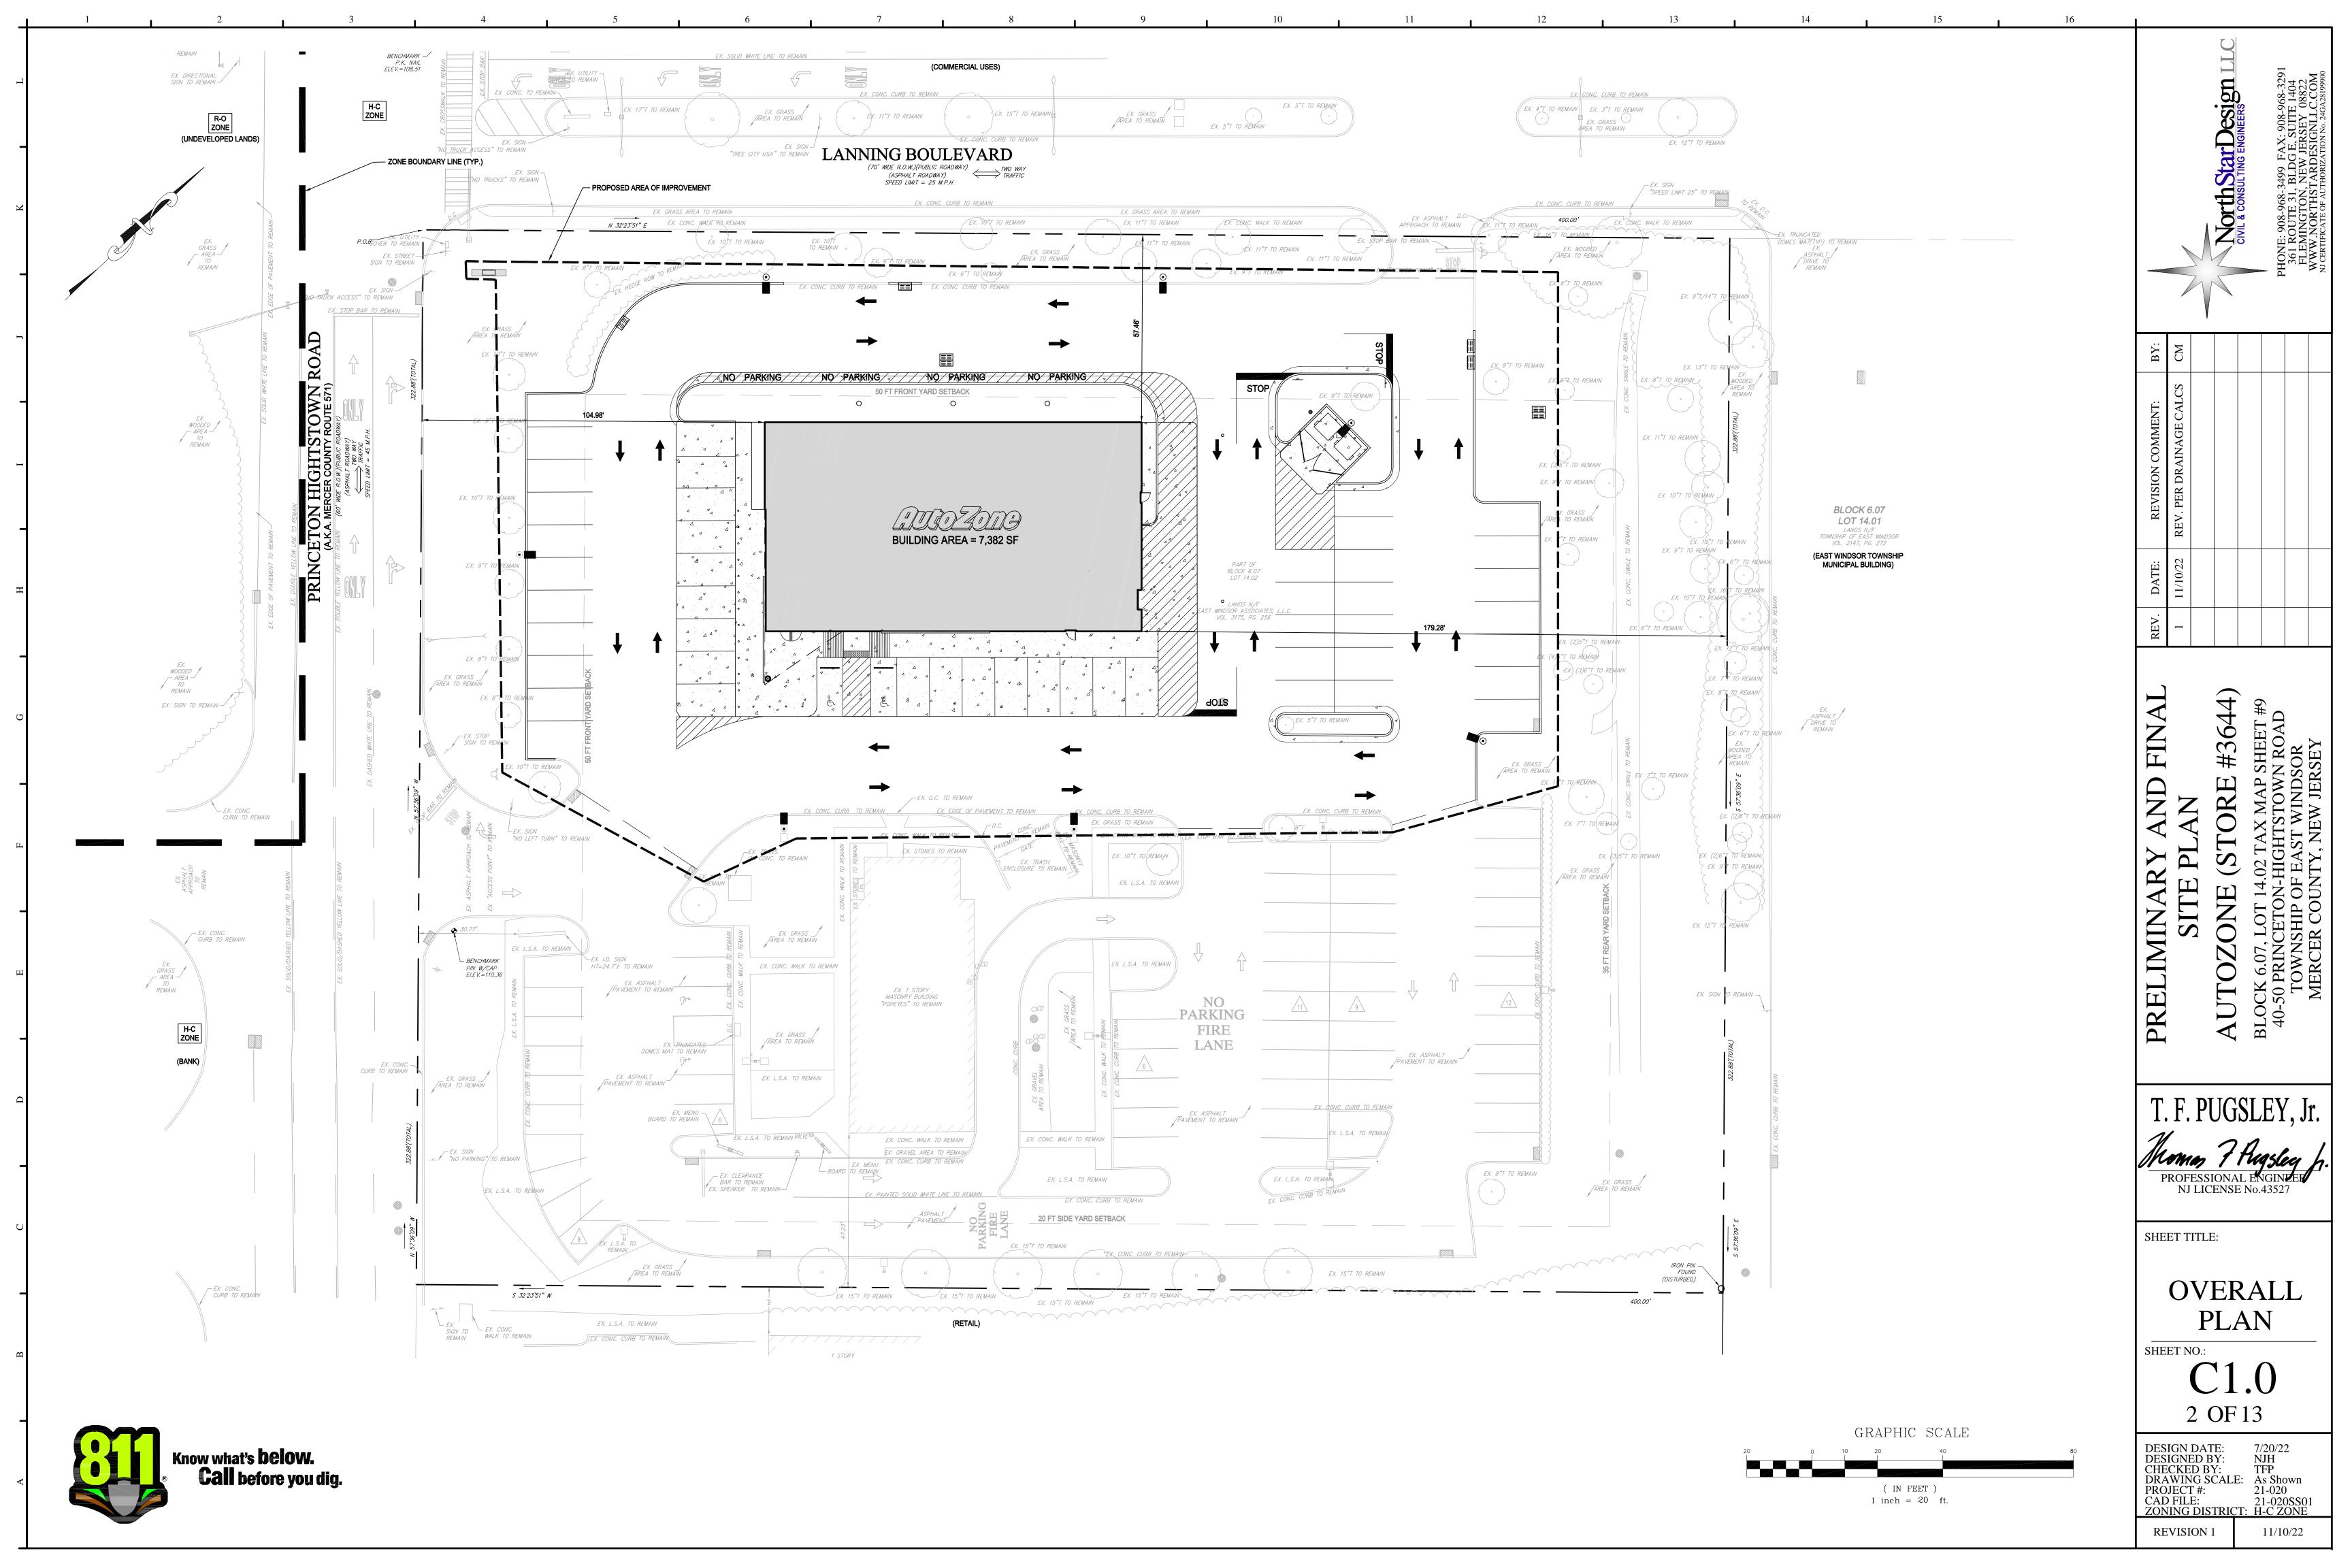

SITE PLAN NOTES

SUBJECT PROPERTY IS LOCATED AT 40-50 PRINCETON-HIGHTSTOWN ROAD IN THE TOWNSHIP OF EAST WINDSOR, AND IS KNOWN AS BLOCK 6.07, LOT 14.02 AS SHOWN ON THE OFFICIAL TAX MAP OF EAST WINDSOR. THE PARCEL IS 129,152 SF (2.965 AC) IN SIZE.

2. PROPERTY OWNER: ROBERT J NASUT C/O: SUMMERWOOD CORP.

14 BALLIGOMINGO ROAD, P.O. BOX 429 CONSHOHOCKEN, PA 19428 APPLICANT: AUTOZONE NORTHEAST, LLC

C/O: DAVID BENTLEY 123 S. FRONT STREET, 3RD FLOOR MEMPHIS, TN 38103

ZONING INFORMATION: PROPERTY IS LOCATED IN THE H-C ZONE (HIGHWAY COMMERCIAL). RETAIL SERVICES ARE A PERMITTED USE

DDINGIDAL DUU DING MINUMUM.	H-C ZONE			
PRINCIPAL BUILDING MINIMUM:	PERMITTED	EXISTING	PROPOSED	
LOT AREA	60,000 SF	129,152 SF	129,152 SF	
LOT WIDTH	250 FT	322.88 FT	322.88 FT	
PRINCIPAL BUILDING YARDS				
FRONT YARD				
(PRINCETON-HIGHTSTOWN ROAD)	50 FT	109.7 FT (PERKINS)	104.98 FT (AUTOZONE)	
FRONT YARD (LANNING BLVD)	50 FT	50.8 FT (PERKINS)	57.46 FT (AUTOZONE)	
SIDE YARD	20 FT	47.23 FT (POPEYES)	47.23 FT (POPEYES)	
REAR YARD	35 FT	202.00 FT (PERKINS)	179.28 FT (AUTOZONE)	
MAX. BUILDING COVERAGE	20%	6.7%	8.1%	
MAX. IMPROVEMENT COVERAGE	80%	64.2%	63.9%	
MAX. BUILDING HEIGHT (FEET)	40 FT	±19.4 FT (PERKINS)	±19 FT (AUTOZONE)	
MAX. FLOOR AREA RATIO	0.3	0.067	0.081	
(EN) = EXISTING NON-CONFORMITY (V) = VARIANCE REQUESTED (N/A) = NOT APPLICABLE				

4. PARKING REQUIREMENTS: (SECTION 19A-2.3)

MIN. PARKING STALL SIZE (SECTION 22-9.2) REQUIRED: 10' X 18' PROPOSED: 10' X 18' OR 10' X 20'

PROPOSED WIDTH:

WIDTH OF AISLES (SECTION 22-9.2) 90° ANGLE TWO-WAY REQUIRED WIDTH:

(TWO WAY) = 24 FT (TWO WAY) = > 24 FT.

MIN. NUMBER OF REQUIRED PARKING SPACES (SECTION 19A-2.3(B.)) PROPOSED RETAIL STORE 5 PARKING SPACES/1,000 SF GROSS LEASING AREA REQUIREMENT:

7,328 SF / 1000 = 7.328 X 5 = 37 SPACES REQUIRED: EXISTING RESTAURANT 1 SPACE/ 40 SF OF PATRON DEVOTED FLOOR AREA REQUIREMENT: ± 1.600 SF FOR PATRON USE / 40 SF = 40 SPACES REQUIRED: TOTAL SPACES REQUIRED: 77 SPACES

TOTAL SPACES PROPOSED: **TOTAL EXISTING SPACES:** 126 SPACES TOTAL PARKING SPACE REDUCTION: 24 SPACES

5. LOADING REQUIREMENTS (SECTION 19A-2.4(A.)) MIN. REQUIRED NUMBER OF LOADING SPACES:

RESTAURANT: ONE (1) SPACE PER USES BETWEEN 2,000-10,000 SF ONE (1) SPACE PER USES BETWEEN 2,000-10,000 SF

REQUIRED: TWO (2) SPACES EXISTING: ONE (1) SPACE (PERKINS) (EN) PROPOSED: ONE (1) SPACE (AUTOZONE) (ÉN)

OFF-STREET LOADING SPACES SIZING REQUIREMENTS (SECTION 19A-2.4(B.)) REQUIRED LOADING SPACE SIZE: 12 FT (W) X 30 FT (L) X 15 FT (H) PROPOSED LOADING SPACE SIZE: 12 FT (W) X 64 FT (L) X >15 FT (H) (COMPLIES)

- THESE PLANS HAVE BEEN DESIGNED BASED ON AN ALTA/NSPS LAND TITLE SURVEY PREPARED BY BLUE MARSH SSOCIATES, INC, DATED 7/29/2021, LAST REVISED 6/9/2022. SURVEY IS CONSIDERED PART OF THE DESIGN DRAWINGS.
- CONTRACTOR IS RESPONSIBLE FOR OBTAINING AND REVIEWING ALL RELEVANT TECHNICAL/DESIGN DOCUMENTS INCLUDING BUT NOT LIMITED TO THE FOLLOWING PRIOR TO CONSTRUCTION:

• GEOTECHNICAL REPORT PREPARED BY DELTA OAKS GROUP, DATED 7/22/2021. ARCHITECTURAL PLANS PREPARED BY AUTOZONE. INC. DATED 05/02/22.


- ONLY SIGNED AND SEALED COPIES OF THE DESIGN DRAWINGS SHOULD BE UTILIZED FOR CONSTRUCTION PURPOSES NORTH STAR DESIGN, LLC. IS NOT RESPONSIBLE FOR ANY CLAIMS DUE TO THE CONTRACTOR CONSTRUCTING WITH INCORRECT PLANS. CONTRACTOR SHALL VERIFY THEY ARE WORKING OFF OF THE LATEST DESIGN DOCUMENTS PRIOR
- 9. UNLESS SPECIFICALLY IDENTIFIED OTHERWISE, IN THE EVENT OF CONFLICTING INFORMATION BETWEEN THESE PLANS AND THE GEOTECHNICAL REPORT, THE GEOTECHNICAL REPORT WILL GOVERN. CONTRACTOR SHOULD IMMEDIATELY
- SHALL REVIEW ALL APPLICABLE PERMITS AND SHALL BE FAMILIAR WITH ALL ASSOCIATED COMMENTS/CONDITIONS 11. ALL CONCRETE SHALL HAVE A MINIMUM COMPRESSIVE STRENGTH OF 4,000 PSI AT 28 DAYS UNLESS OTHERWISE
- IDENTIFIED ON THESE PLANS.
- 12. THE CONTRACTOR SHALL COMPLY WITH ALL FEDERAL, STATE, LOCAL AND THE LATEST OSHA STANDARDS AND
- 13. CONTRACTOR IS SOLELY RESPONSIBLE FOR THE DETERMINING THE MEANS AND METHODS TO CONSTRUCT THE PROPOSED IMPROVEMENTS PRIOR TO COMMENCING CONSTRUCTION.
- ALL HANDICAP PARKING SPACES AND ACCESSIBLE ROUTES SHALL BE CONSTRUCTED TO COMPLY WITH THE VARIOUS AGENCIES THAT HAVE JURISDICTION (I.E. THE "AMERICANS WITH DISABILITIES ACT (ADA)" AND THE NJ BARRIER FREE REGULATIONS OR THE REQUIREMENTS OF THE JURISDICTION WHERE THE PROJECT IS TO BE CONSTRUCTED). THE
- 15. NORTH STAR DESIGN, LLC. IS NOT RESPONSIBLE FOR JOB SITE SAFETY. THE OWNER OR GENERAL CONTRACTOR IS RESPONSIBLE TO DESIGNATE AN INDIVIDUAL RESPONSIBLE FOR CONSTRUCTION SITE SAFETY IN ACCORDANCE WITH N.J.A.C. 5:23-2.21(E) OF THE UNIFORM CONSTRUCTION CODE. NORTH STAR DESIGN, LLC AND/OR ITS SUBCONSULTANTS HAVE NO AUTHORITY TO EXERCISE ANY CONTROL OVER ANY CONTRACTOR IN CONNECTION WITH THEIR WORK AND/OR SAFETY PROCEDURES. THE GENERAL CONTRACTOR IS SOLELY RESPONSIBLE FOR JOB SITE SAFETY.
- 16. CONTRACTOR RESPONSIBLE TO MAINTAIN A SECURE SITE DURING CONSTRUCTION.
- EXISTING CONDITIONS MAY HAVE CHANGED DURING THE APPROVAL PROCESS. CONTRACTOR TO VERIFY ALL EXISTING FEATURES PRIOR TO START OF CONSTRUCTION. ANY DISCREPANCIES SHALL BE IMMEDIATELY PROVIDED TO DESIGN ENGINEER IN WRITING. NO ADDITIONAL COMPENSATION WILL BE PAID TO CONTRACTOR AS A RESULT OF ANY DISCREPANCY WITHOUT OBTAINING WRITTEN APPROVAL TO PROCEED FROM THE DESIGN ENGINEER. ANY DEVIATION FROM THE APPROVED PLAN WITHOUT WRITTEN APPROVAL IS AT THE CONTRACTORS OWN RISK AND NORTH STAR DESIGN, LLC SHALL BE INDEMNIFIED BY CONTRACTOR FROM RESULTING COSTS.
- 18. CONTRACTOR IS RESPONSIBLE TO ENSURE THAT THE EXISTING SITE FEATURES ON THE ADJACENT PROPERTIES ARE NOT NEGATIVELY IMPACTED DURING CONSTRUCTION. CONTRACTOR SHALL RESTORE ANY DAMAGED FEATURES TO A CONDITION EQUAL OR BETTER THAN THAT WHICH WAS PRESENT PRIOR TO START OF CONSTRUCTION.
- 19. CONTRACTOR IS RESPONSIBLE TO REMOVE ALL CONSTRUCTION DEBRIS FROM SITE IN ACCORDANCE WITH ALL STATE
- AND LOCAL REGULATIONS. NO CONSTRUCTION DEBRIS IS PERMITTED TO BE BURIED ON SITE.
- 20. THE CONTRACTOR SHALL BE RESPONSIBLE FOR ALL NECESSARY TRAFFIC CONTROL MEASURES. ALL TRAFFIC CONTROL SIGNAGE SHALL COMPLY WITH THE REQUIREMENTS OF THE "MANUAL ON UNIFORM TRAFFIC
- CONTROL DEVICES", LATEST EDITION AS ISSUED BY THE U.S. FEDERAL HIGHWAY ADMINISTRATION.
- 22. THE CONTRACTOR SHALL CONTACT THE NEW JERSEY STATE UTILITY ONE CALL SYSTEM PRIOR TO START OF CONSTRUCTION AND IS RESPONSIBLE TO PROTECT EXISTING UTILITIES DURING CONSTRUCTION.
- 23. THE PROPOSED IMPERVIOUS COVERAGE IS APPROXIMATELY ±82,626 SF WHICH IS LESS THAN THE ±82,870 SF UNDER
- 24. THE SUBJECT SITE IS LOCATED OUTSIDE OF THE 100 YEAR FLOOD PLAIN PER FEMA MAP 3402K0168F DATED JULY 20,

#### PROPOSED SIGN LEGEND

- A AUTOZONE FREESTANDING SIGN B AUTOZONE SIGN (EAST FACADE)
- C AUTOZONE SIGN (SOUTH FACADE)

#### **EXISTING SIGN LEGEND**

A POPEYES FREESTANDING SIGN

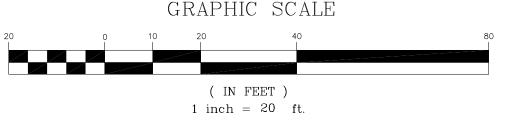

## Accessible Ramp - See detail 18 /C1.6 - Max. slope 1:12 (8.33%), Max. cross slope 1:50 (2.00%) Truncated dome \( \begin{pmatrix} \text{18} \end{pmatrix} \) New landscape area - Provide 3" topsoil & sod. See (20) Loading Area: slope at max. 2-1/2% away from building $\langle 21 \rangle$ Contractor to paint curbing yellow within area indicated Sawcut and remove existing asphalt for installation of $\langle 24 \rangle$ Stop Bar and Pavement Markings - See detail 1 sheet C1.7

NorthStarDesign

ONE: 908-968-3499 FAX: 908-968-32 361 ROUTE 31, BLDG E, SUITE 1404 FLEMINGTON, NEW JERSEY 08822 WW.NORTHSTARDESIGNLLC.COM

**KEYNOTES** 

Dumpster layout - see details 8,9,10 & 11/ C1.6

Concrete light pole base - See Details 12 /C1.6.

6 Curb & gutter @ concrete paving - see detail 1 / C1.6

(7) Curb & gutter @ asphalt paving - see detail 2 / C1.6

Aim light fixture in direction as indicated.

(8) Concrete vertical curb - see detail 20 / C1.6

control joints is 15' O.C. each way.

(13) 4" wide parking stripe painted white (typ.)

(11) Asphalt paving - see dtl. 3/ C1.6.

sidewalks around building

to be a contrasting color.

site features

25 Freestanding Sign

28 Freezeless Yard Hydrant

sheet L1.0 for additional information

(23) Truncated Dome - See detail 3, sheet C1.7

(26) Sanitary Sewer Cleanout - See Detail 3, sheet C1.8

27 Storm Sewer Cleanout - See Detail 4, sheet C1.8

GENERAL NOTES

Edge of new pavement to be flush with existing pavement

driveway approaches, handicap ramp, etc. constructed outside the property line in the right-of-way shall conform to all municipal and/or state specifications and

For areas outside the property lines, repair and/or replace all damage done to existing elements (sidewalks, paving, andscaping, etc.) as required by owner and/or governing

. Proof roll building and all parking areas. Notify the

3. All sidewalk curb and gutter street paving, curb cuts,

5. For proposed utility locations, see the utility plan.

PARKING SPACE SUMMARY

49 SPACES

53 SPACES

102 SPACES

AUTOZONE:

POPEYE'S:

Architect of any unacceptable areas.

(19) Stop Sign - See Detail 5, sheet C1.7

 $\langle$  9  $\rangle$  G.C. to provide alternate bid for concrete paving,

(12) 6'-0" long concrete wheel stop pinned to pavement (typical). Locate 3'-6" from face of curb or sidewalk See

4" wide diagonal stripes painted Blue at 2 ft. O.C. Handicap parking sign - see detail 19/ C1.6 G.C. to provide (1) Van Accessible signs. (16) Concrete sidewalk - see detail 5 & 27/ C1.6 for

(10) Concrete paving - see dtl. 4/C1.6 Expansion and Control

joints - see dtls. 22 & 23/ C1.6. Maximum spacing for

BUILDING & PAVING

1 Pipe Guard - see details 15/ C1.6

4 Bollard Plan - see detail 13/ C1.6

where noted

detail 16 / C1.6

3 Service Door Plan - see detail 14/ C1.6

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PROFESSIONAL ENGINE NJ LICENSE No.43527

SHEET TITLE:

SHEET NO.:

3 OF 13

DESIGNED BY: CHECKED BY: DRAWING SCALE: As Shown PROJECT #: CAD FILE:

ZONING DISTRIC


11/10/22

7/20/22

21-020

21-020SS01

H-C ZONE **REVISION 1** 

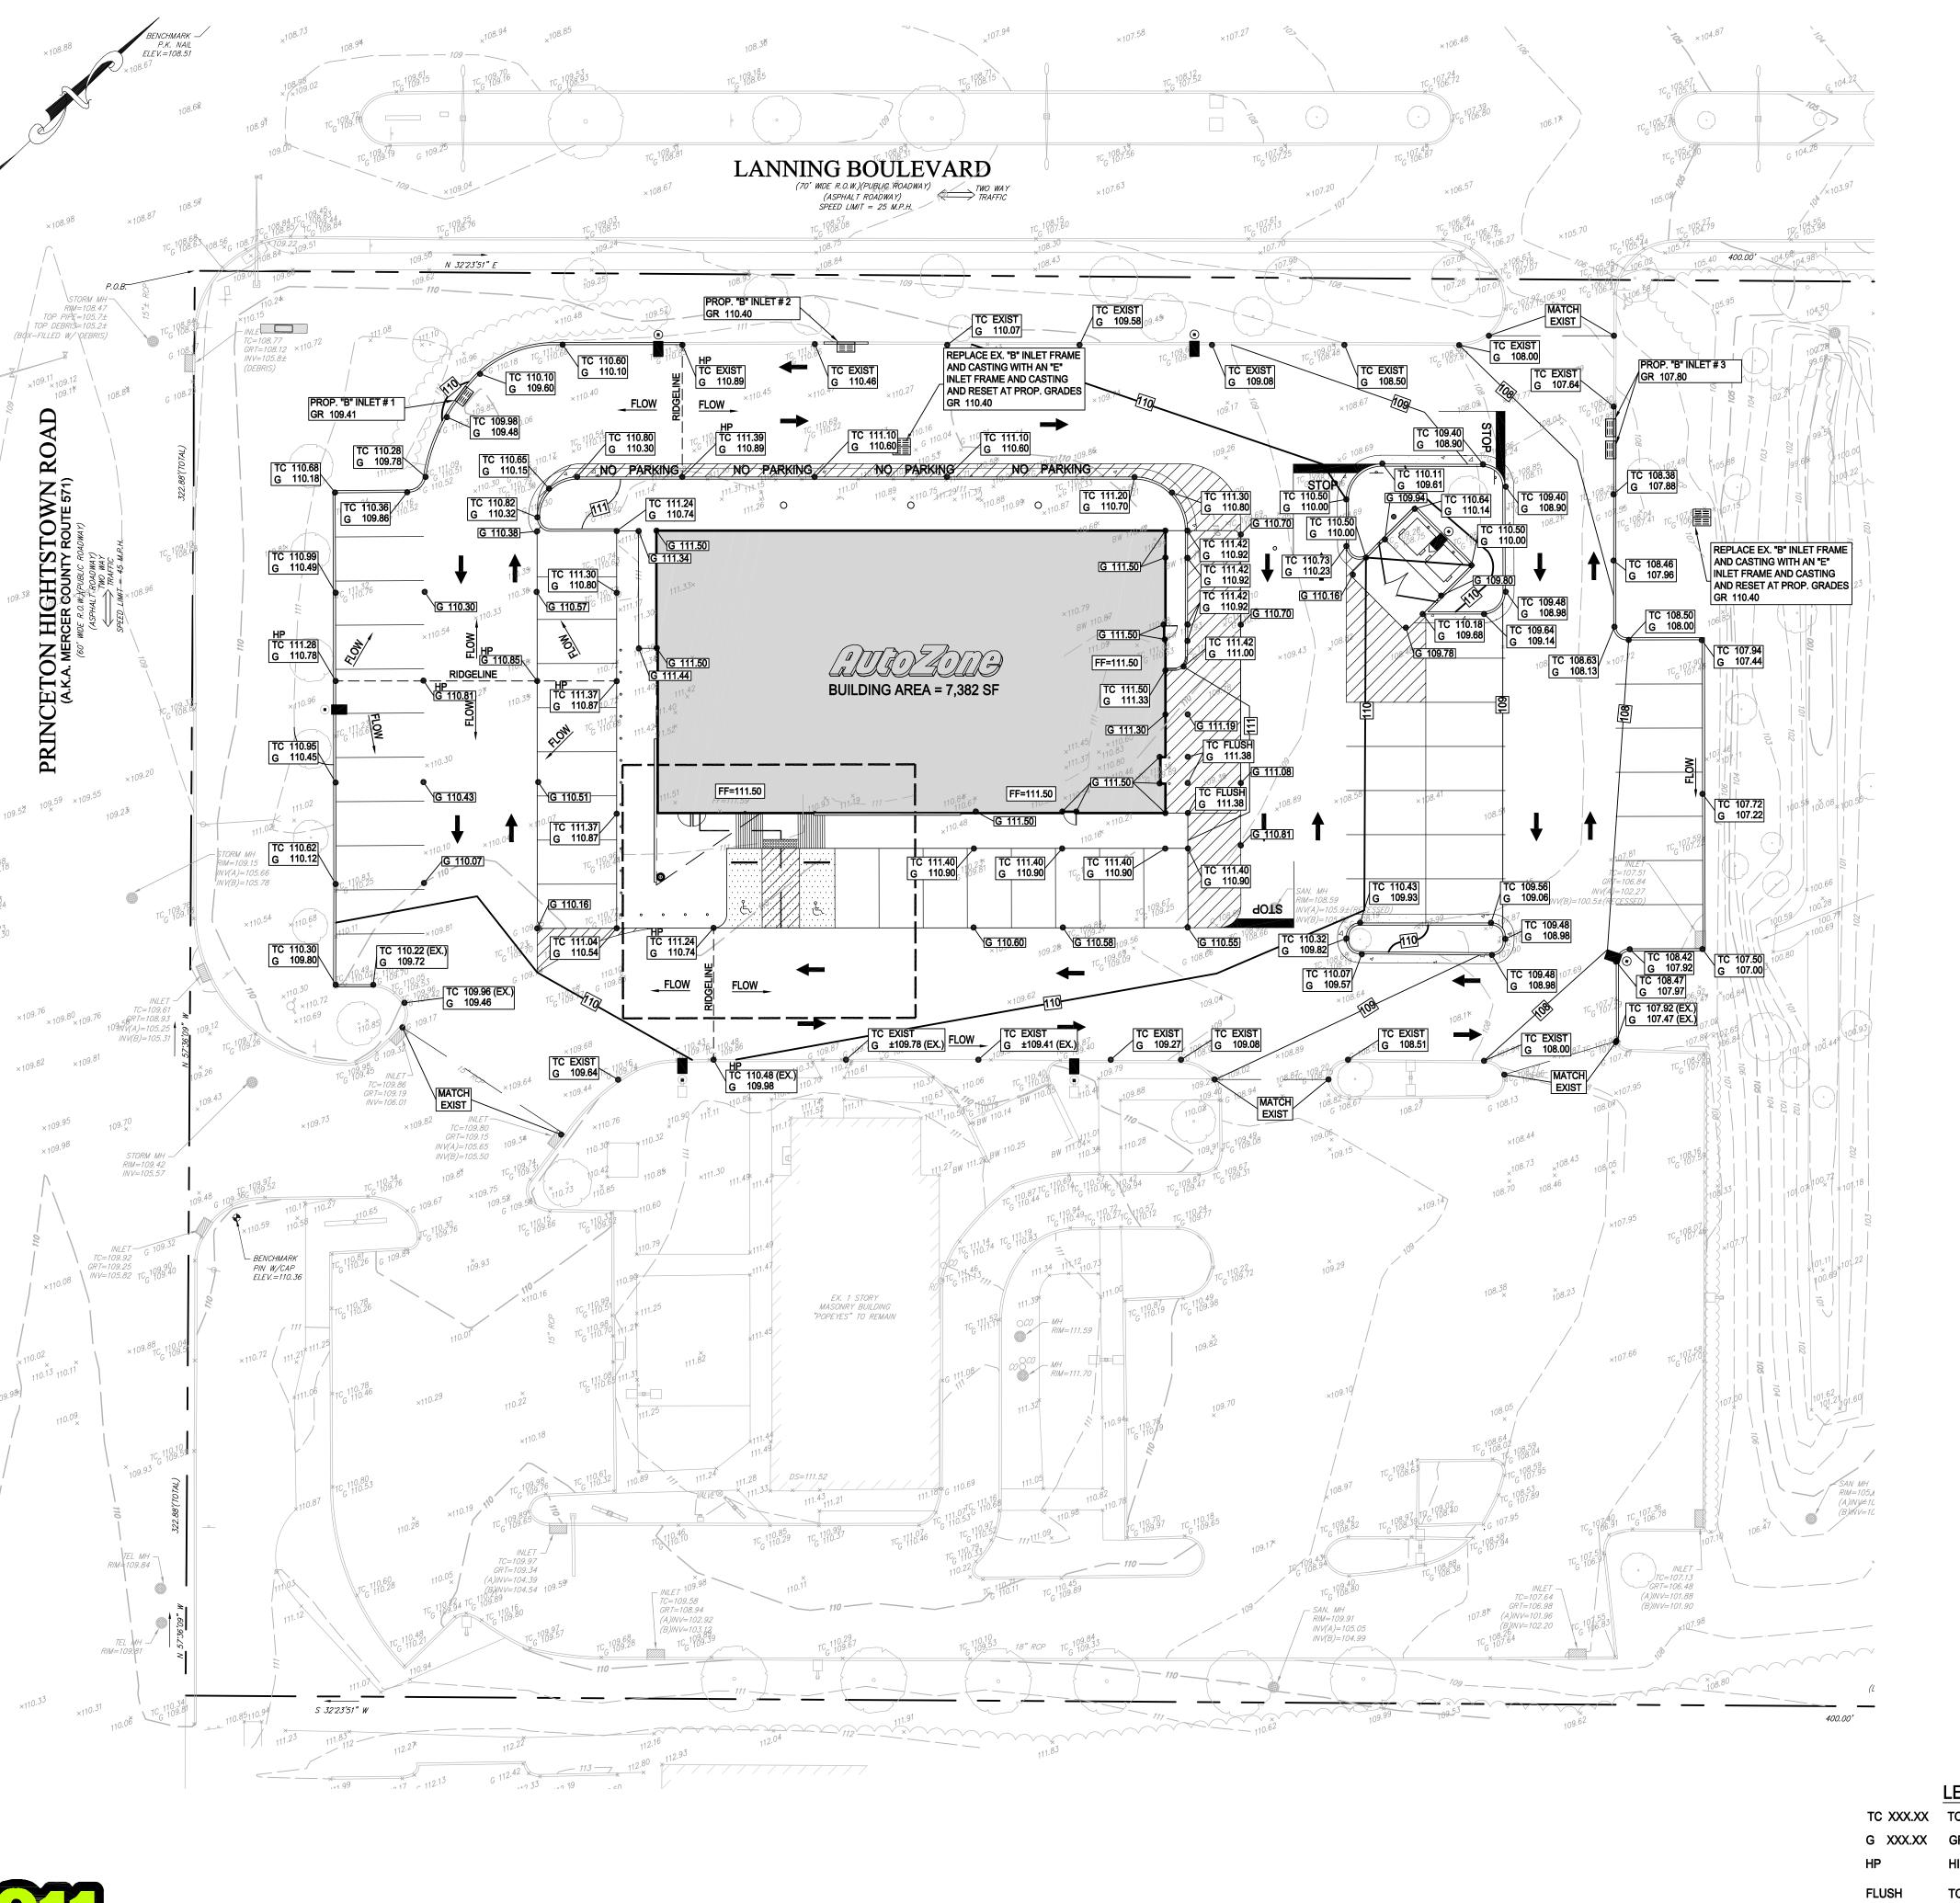

Know what's **below. Call** before you dig.

**GRADING NOTES:** 

THE BOUNDARY AND/OR TOPOGRAPHIC SURVEY AND GEOTECHNICAL REPORT SHALL BE CONSIDERED PART OF THESE DOCUMENTS.

CONTRACTOR TO INSTALL THE PROPOSED IMPROVEMENTS TO COMPLY WITH THE DESIGN STANDARDS PROVIDED IN THE LATEST ADA AND NJ BARRIER FREE REGULATIONS.

CONTRACTOR IS RESPONSIBLE FOR REVIEWING ALL DESIGN DRAWINGS AND SPECIFICATIONS PRIOR TO INITIATING CONSTRUCTION. SHOULD ANY CONFLICTS BE IDENTIFIED BETWEEN THE DESIGN DOCUMENTS AND/OR RELATIVE CODES, THE DESIGN ENGINEER SHOULD IMMEDIATELY

4. FINISHED GRADE SLOPES WITHIN THE LIMITS OF THE HANDICAP PARKING SPACES AND ITS ASSOCIATED STRIPED AREAS SHALL NOT EXCEED 2% IN ANY DIRECTION.

FINISHED GRADE SLOPES ALONG THE ACCESSIBLE ROUTE SHALL NOT HAVE A CROSS SLOPE OF MORE THAN 2% AND A LONGITUDINAL SLOPE MORE THAN 5%.

A MINIMUM OF 5 FT OF A MAXIMUM OF 2% SLOPES IN ANY DIRECTION MUST BE PROVIDED AT ALL ADA ACCESSIBLE ENTRANCES TO THE BUILDINGS.

THE CONTRACTOR SHALL VERIFY ALL EXISTING GRADES PRIOR TO CONSTRUCTION. IN ORDER TO PREVENT THE PONDING OF WATER, ALL GRADES SHALL HAVE A MINIMUM SLOPE OF THE FOLLOWING UNLESS OTHERWISE NOTED ON THE PLAN: 0.75% ALONG GUTTERLINES AND CURBLINES, 1% ALONG ALL CONCRETE AREAS AND 1.5% ALONG ALL PAVEMENT SURFACES. SHOULD ANY DISCREPANCIES ARISE BETWEEN THESE MINIMUMS AND THE PLANS, THE ENGINEER SHALL BE NOTIFIED IMMEDIATELY IN WRITING.

CONTRACTOR IS RESPONSIBLE FOR VERIFYING THE EXISTING TOPOGRAPHY PRIOR TO COMMENCING CONSTRUCTION. ANY DISCREPANCIES SHOULD IMMEDIATELY BE PROVIDED TO THE DESIGN ENGINEER IN WRITING. PROCEEDING WITHOUT PROVIDING PROPER NOTIFICATION IS DONE AT THE CONTRACTORS OWN RISK.


CONTRACTOR IS RESPONSIBLE FOR PROVIDING A SMOOTH TRANSITION BETWEEN THE PROPOSED ASPHALT AND THE EXISTING ASPHALT TO REMAIN. POSITIVE DRAINAGE IS TO BE PROVIDED TO PREVENT PONDING. ANY PONDING CREATED AS A RESULT OF THE INSTALLATION OF THE PROPOSED IMPROVEMENTS SHALL BE REPAIRED BY CONTRACTOR AT THEIR OWN COST.

PRIOR TO INITIATING CONSTRUCTION, CONTRACTOR SHALL CONTACT THE NJ ONE CALL SYSTEM BY DIALING 811 OR 1-800-272-1000 TO LOCATE ALL EXISTING UTILITY INFRASTRUCTURE WITHIN THE LIMIT OF DISTURBANCE.

11. THE CONTRACTOR SHALL COMPLY TO THE FULLEST EXTENT POSSIBLE WITH THE LATEST OSHA STANDARDS AND REGULATIONS OR ANY OTHER AGENCY HAVING JURISDICTION.

12. PROPOSED CURBING SHALL HAVE A 6" REVEAL UNLESS OTHERWISE NOTED ON THE DESIGN

13. THE PROPOSED IMPROVEMENTS HAVE BEEN DESIGNED TO BE CONSISTENT WITH THE EXISTING TOPOGRAPHY AND DRAINAGE PATTERNS. UPON COMPLETION OF CONSTRUCTION, ANY DRAINAGE ISSUES AROUND THE LIMITS OF THE PROPOSED IMPROVEMENTS SHALL BE MODIFIED

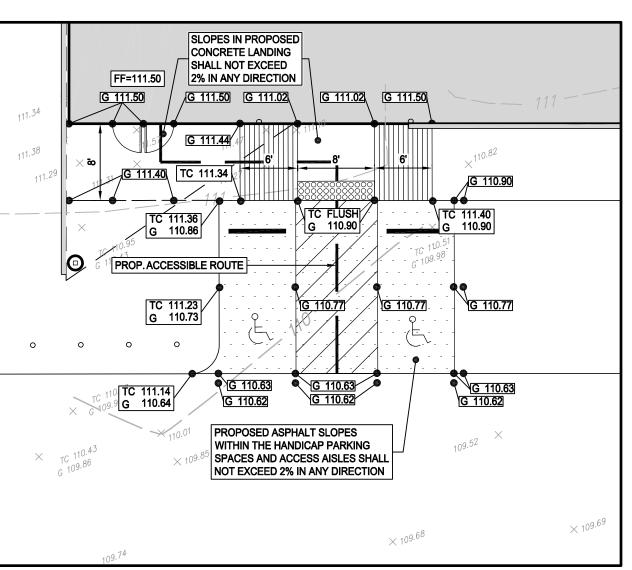

INSET 'A' SCALE: 1"=10'

**LEGEND** 

TC XXX.XX TOP OF CURB ELEVATION **GRADE ELEVATION** 

TOP OF CURB ELEVATION IS FLUSH WITH GRADE MATCH EXISTING TOP OF CURB AND **GRADE ELEVATIONS** 

GRAPHIC SCALE ( IN FEET ) 1 inch = 20 ft.

North Star Design CIVIL & CONSULTING ENGINEERS

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PRELIMIN

T. F. PUGSLEY, Jr.

PROFESSIONAL ENGINEE NJ LICENSE No.43527

SHEET TITLE: **GRADING &** DRAINAGE **PLAN** 


SHEET NO.:

4 OF 13

DESIGN DATE: 7/20/22
DESIGNED BY: NJH
CHECKED BY: TFP
DRAWING SCALE: As Shown
PROJECT #: 21-020
CAD FILE: 21-020SS01
ZONING DISTRICT: H-C ZONE

11/10/22

**REVISION 1** 

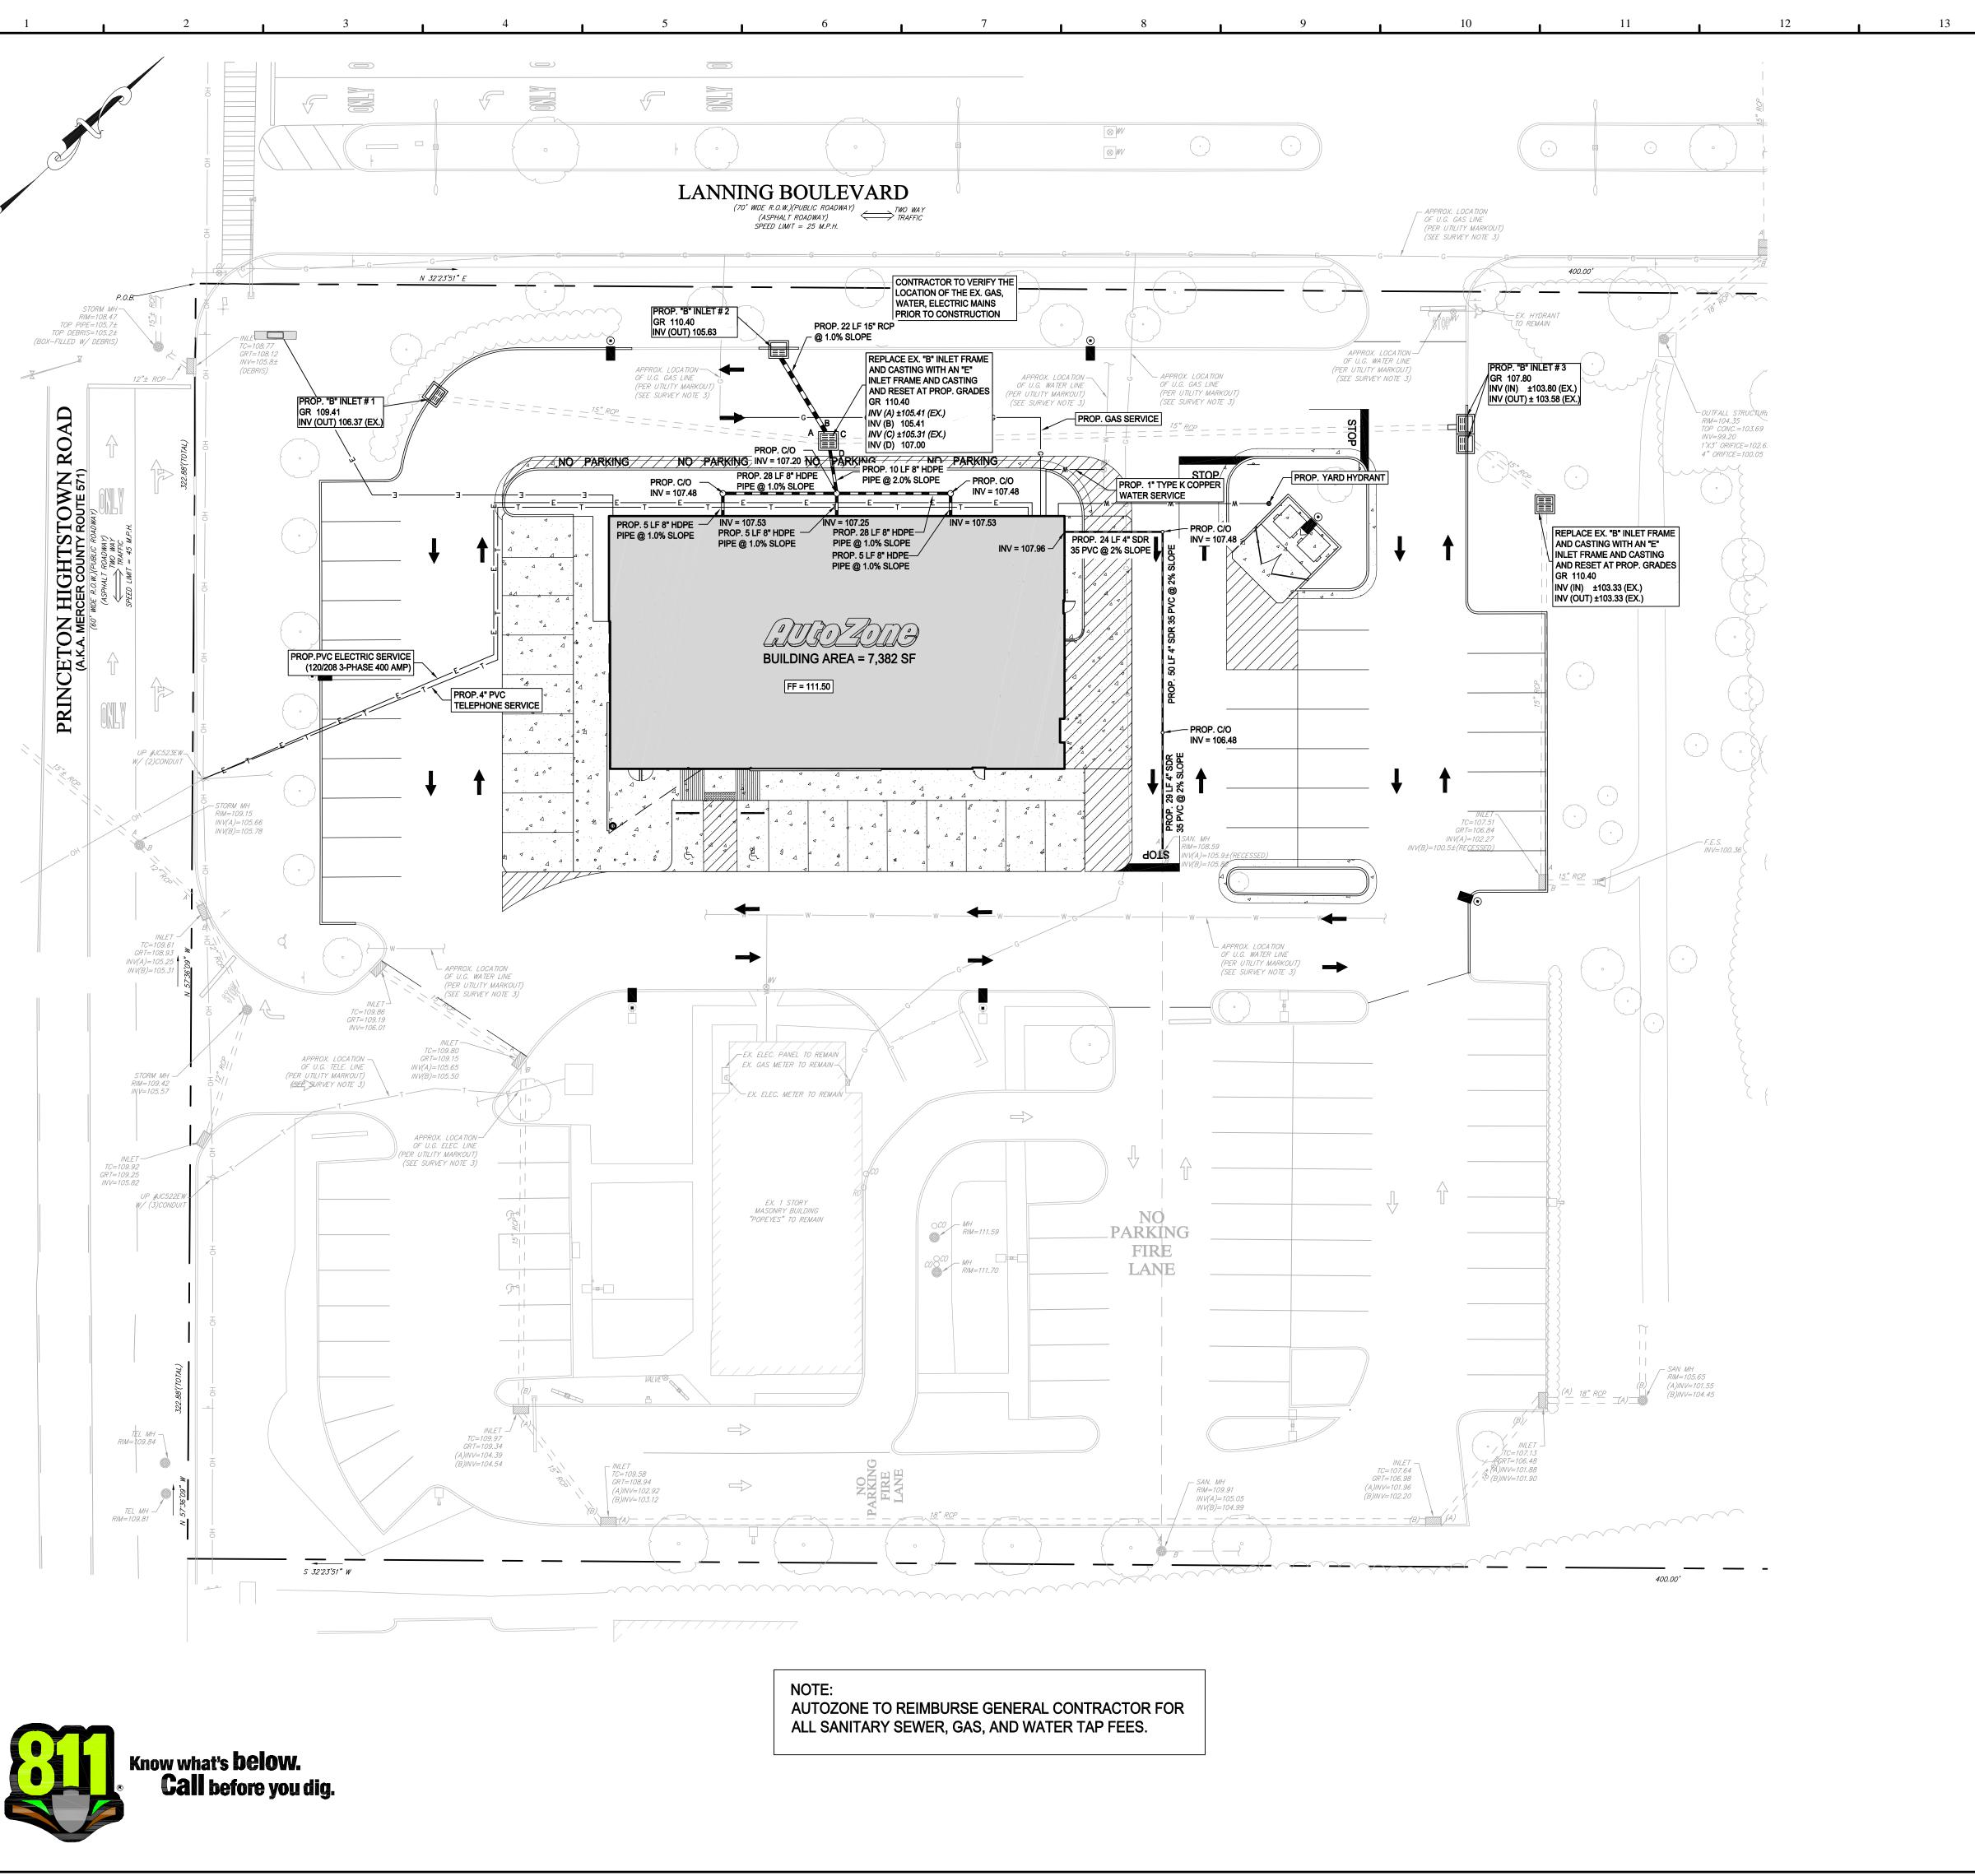

#### **UTILITY NOTES:**

- THE LOCATIONS OF ALL UNDERGROUND UTILITIES ARE APPROXIMATE. THE CONTRACTOR IS RESPONSIBLE FOR COORDINATING WITH THE RESPECTIVE UTILITY COMPANIES FOR A MARKOUT PRIOR TO CONSTRUCTION. CONTRACTOR SHALL UTILIZE THE ONE-CALL SYSTEM (DIAL 811) AND/OR ANY OTHER APPLICABLE UNDERGROUND UTILITY NOTIFICATION SYSTEM. ANY EXISTING ON-SITE UTILITY SERVICES SHALL BE LOCATED BY THE CONTRACTOR PRIOR TO CONSTRUCTION. ANY DISCREPANCIES BETWEEN THE PROPOSED PLAN AND THE EXISTING UTILITY LOCATIONS SHALL BE IMMEDIATELY REPORTED TO THE ENGINEER IN WRITING.
- ALL CONNECTION POINTS SHALL BE CONFIRMED IN THE FIELD AND SHALL BE COORDINATED WITH THE APPLICABLE UTILITY COMPANY PRIOR TO CONSTRUCTION. ANY UTILITY CROSSINGS INVOLVING EXISTING UTILITIES SHALL BE FIELD VERIFIED VIA TEST PITS PRIOR TO CONSTRUCTION.
- THE CONTRACTOR IS RESPONSIBLE TO PROTECT ALL EXISTING ABOVEGROUND AND UNDERGROUND FEATURES AND UTILITIES DURING CONSTRUCTION. ANY DAMAGE TO EXISTING UTILITIES WILL BE THE SOLE RESPONSIBILITY OF THE CONTRACTOR AT NO COST TO THE OWNER.
- 4. ALL PROPOSED UTILITIES SHALL BE INSTALLED IN ACCORDANCE WITH THE APPLICABLE UTILITY COMPANY
- 5. THE CONTRACTOR IS RESPONSIBLE TO REVIEW ALL DRAWINGS AND APPLICABLE CODES PRIOR TO CONSTRUCTION. SHOULD A CONFLICT ARISE BETWEEN THE PLANS AND/OR SPECIFICATIONS AND THE APPLICABLE CODES, THE CONTRACTOR SHALL IMMEDIATELY NOTIFY THE ENGINEER IN WRITING.
- ANY UTILITY THAT IS PROPOSED TO BE ABANDONED WILL BE DONE SO BY THE CONTRACTOR IN ACCORDANCE WITH THE APPLICABLE CODES AND REGULATIONS.
- THE FINAL UTILITY SIZES AND UTILITY CONNECTION POINTS INTO THE BUILDING SHALL BE DESIGNED BY THE PROJECT ARCHITECT. THE CONTRACTOR IS RESPONSIBLE FOR OBTAINING AND FAMILIARIZING THEMSELVES WITH THE FINAL ARCHITECTURAL PLANS. ANY DISCREPANCIES BETWEEN THE SITE PLANS AND THE ARCHITECTURAL PLANS SHALL BE IMMEDIATELY REPORTED TO THE ENGINEER IN WRITING.
- ALL UTILITY COMPONENTS, SUCH AS VALVES, FITTINGS, ETC, SHALL BE IN ACCORDANCE WITH THE LOCAL UTILITY COMPANY HAVING JURISDICTION.
- ALL BACKFILL MATERIAL, ASPHALT MATERIAL, SUBBASE MATERIAL AND ASSOCIATED CONSTRUCTION PROCEDURES AND RECOMMENDATIONS SHALL BE IN ACCORDANCE WITH THE GEOTECHNICAL REPORT. THE CONTRACTOR IS RESPONSIBLE FOR OBTAINING AND FAMILIARIZING THEMSELVES WITH SAID REPORT
- 10. THE CONTRACTOR SHALL COMPLY WITH ALL FEDERAL, STATE, LOCAL AND THE LATEST OSHA STANDARDS AND REQUIREMENTS AT ALL TIMES. THE CONTRACTOR IS RESPONSIBLE FOR THE "MEANS AND METHODS" OF CONSTRUCTION WHILE STILL MAINTAINING COMPLIANCE WITH OSHA. THE CONTRACTOR IS SOLELY RESPONSIBLE FOR JOB SITE SAFETY. NORTH STAR DESIGN, LLC AND.OR IT'S SUBCONSULTANTS HAVE NO AUTHORITY TO EXERCISE ANY CONTROL OVER ANY CONTRACTOR IN CONNECTION WITH THEIR WORK
- 11. ANY REMOVAL OF SOIL AND/OR DEBRIS SHALL BE DISPOSED OF IN ACCORDANCE WITH ALL APPLICABLE LAW AND REGULATIONS.
- 12. THE CONTRACTOR SHALL VERIFY ALL EXISTING GRADES PRIOR TO CONSTRUCTION.
- 13. THE CONTRACTOR SHALL ENSURE A SMOOTH TRANSITION AND POSITIVE DRAINAGE BETWEEN EXISTING ASPHALT/CONCRETE AND PROPOSED ASPHALT/CONCRETE.
- 14. FOR GRAVITY SYSTEMS SUCH AS STORM SEWER SYSTEMS AND SANITARY SEWER SYSTEMS, THE CONSTRUCTION SHALL START AT THE LOWEST INVERT AT THE TIE-IN POINT AND CONTINUE UPSTREAM TO
- 15. CONTRACTOR IS RESPONSIBLE FOR ALL DEWATERING MEASURES REQUIRED TO CONSTRUCT THE PROPOSED IMPROVEMENTS.
- 16. CONTRACTOR TO BE RESPONSIBLE FOR VERIFYING AND APPLYING FOR UTILITY SERVICE WITH EACH UTILITY COMPANY PRIOR TO STARTING CONSTRUCTION.
- 17. CONTRACTOR TO BE RESPONSIBLE FOR STREET BORE, IF REQUIRED BY THE TOWNSHIP OF EAST
- 18. BACKFLOW PREVENTOR TO BE LOCATED WITHIN THE PROPOSED STRUCTURES.
- 19. A PULL ROPE SHALL BE PROVIDED FROM CONNECTION POINT TO TELEPHONE BOARD LOCATION IN BUILDING.
- 20. CONTRACTOR TO ADVISE BOARD ENGINEER A MINIMUM OF 48 HOURS IN ADVANCE OF RESETTING EXISTING 15" PIPES. CONTRACTOR TO PROVIDE PHOTOGRAPHS AND REPORT OF PIPE INSPECTION TO THE BOARD ENGINEER FOR THEIR FILES.

#### UTILITY CONTACT INFORMATION

VERIZON 540 BROAD STREET **NEWARK, NJ 07101** 

PHONE: 175 WEST MAIN ST

CABLE: COMCAST CABLEVISION P.O. BOX 790, 90 LAKE DRIVE EAST WINDSOR, NJ 08520

WATER & SEWER: EAST WINDSOR UTILITIES AUTHORITY 7 WILTSHIRE DRIVE EAST WINDSOR, NJ 08520

TRANSCONTINENTAL GAS PIPE LINE CORP. 3200 SOUTH WOOD AVE

LINDEN, NJ 07036-0005

MORRISTOWN, NJ 07962

**EXISTING STORM INLET (TYPE B)** 

ELECTRIC: PSE&G CO. PO BOX 800 NEWARK, NJ 07101

(973) 430-7135 ELECTRIC: JCP&L C/O GPU ENERGY 300 MADISION AVE

#### **UTILITY LEGEND**

PROPOSED STORM INLET (TYPE A) PROPOSED STORM MANHOLE PROPOSED CLEAN OUT **EXISTING STORM PIPE** PROPOSED STORM PIPE **EXISTING SANITARY PIPE** PROPOSED SANITARY PIPE **EXISTING WATER SERVICE** ---- W-----PROPOSED WATER SERVICE EXISTING GAS SERVICE ---- G-----PROPOSED GAS SERVICE EXISTING ELECTRIC SERVICE ---- E -----PROPOSED ELECTRIC SERIVCE **EXISTING TELEPHONE SERVICE** ---- T-----PROPOSED TELEPHONE SERVICE

**EXISTING LIGHT FIXTURE** PROPOSED LIGHT FIXTURE

**EXISTING FIRE HYDRANT** 

PROFESSIONAL ENGINEER NJ LICENSE No.43527 SHEET TITLE:

**PRELIMINAR** 

**UTILITY PLAN** 

T. F. PUGSLEY, Jr.

North Star Design

HONE: 908-968-3499 FAX: 908-968-32 361 ROUTE 31, BLDG E, SUITE 1404 FLEMINGTON, NEW JERSEY 08822 WWW.NORTHSTARDESIGNLLC.CONCERTHECATE OF ALTHORIZATION No. 24GA 28, 99991

SHEET NO.: 5 OF 13

DESIGN DATE: DESIGNED BY: 7/20/22 NJH CHECKED BY: TFP DRAWING SCALE: As Shown PROJECT #: CAD FILE:

ZONING DISTRIC : H-C ZONE **REVISION 1** 

11/10/22


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21-020SS01

GRAPHIC SCALE

( IN FEET )

1 inch = 20 ft.

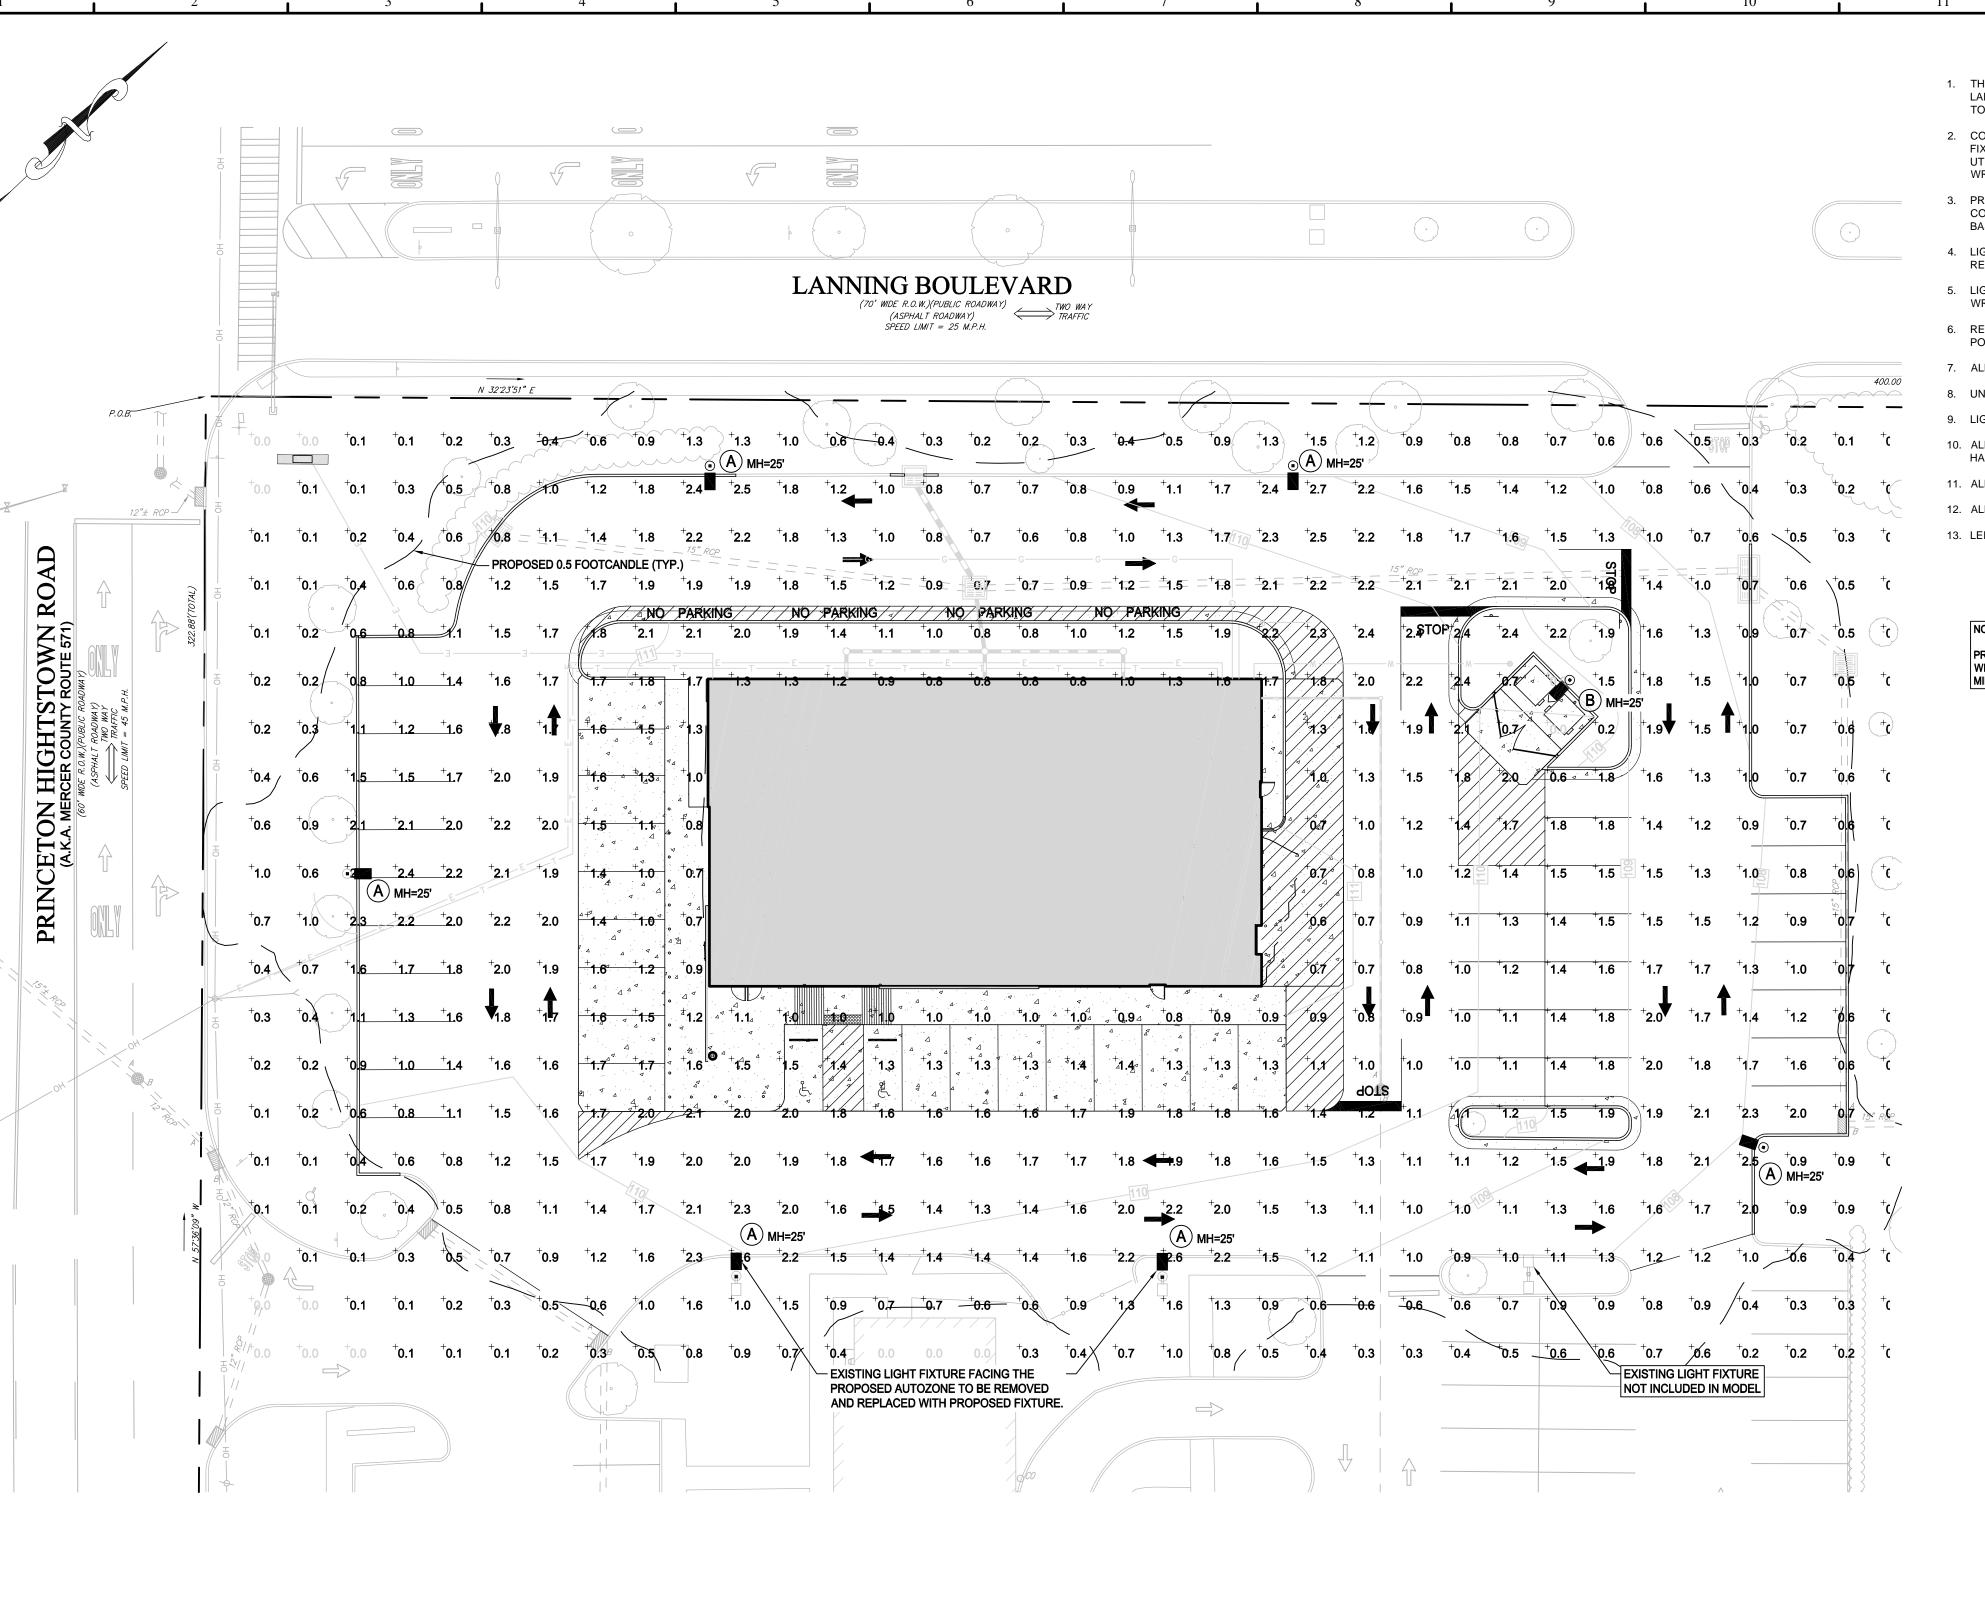


#### **LIGHTING NOTES:**


- 1. THIS PLAN HAS BEEN PREPARED UTILIZING PHOTOMETRIC DATA PROVIDED BY THE MANUFACTURERS FOR THE INDIVIDUAL LIGHT FIXTURE(S) SPECIFIED. THIS DATA IS BASED ON LABORATORY ANALYSIS WHICH HAS BEEN TESTED PER THE REQUIREMENTS OF THE ILLUMINATING ENGINEERING SOCIETY OF NORTH AMERICA. ACTUAL FIELD CONDITIONS MAY VARY DUE TO ELECTRICAL SOURCE, FIXTURE TOLERANCES, ENVIRONMENTAL AND OTHER FIELD CONDITIONS.
- 2. CONTRACTOR TO COORDINATE WITH LOCAL ELECTRICAL SERVICE PROVIDER WHEN THE SERVICE PROVIDERS EXISTING WIRE NETWORK IS IN CLOSE PROXIMITY TO THE PROPOSED LIGHT FIXTURE. CONTRACTOR TO MAINTAIN ALL MINIMUM DISTANCES REQUIRED FROM ELECTRICAL WIRES AS REQUIRED BY THE LOCAL SERVICE PROVIDER AND/OR THE BOARD OF PUBLIC
- 3. PROPOSED LIGHT POLES TO BE INSTALLED IN LANDSCAPED AREAS SHALL BE A MINIMUM OF 2' 6" BACK FROM THE FACE OF CURB OR EDGE OF PAVEMENT. LIGHT POLES THAT DO NOT COMPLY WITH THE AFOREMENTIONED REQUIREMENTS OR ARE LOCATED WITHIN A DRIVEABLE AREA (ASPHALT, CONCRETE, CRUSHED STONE, ETC.) SHALL BE INSTALLED ON A CONCRETE
- 4. LIGHT POLES INSTALLED WITHIN PARKING LOTS SHALL BE INSTALLED IN A STRIPED AREA NOT UTILIZED FOR PARKING OR SHALL BE CENTERED AT THE INTERSECTION OF THE STRIPING
- 5. LIGHT POLES SHALL NOT BE INSTALLED ON TOP OF ANY EXISTING AND/OR PROPOSED UTILITY. ANY DISCREPANCIES SHALL BE PROVIDED TO THE DESIGN ENGINEER IMMEDIATELY IN
- 6. REFER TO THE ELECTRICAL PLANS FOR THE PROPOSED BUILDING TO IDENTIFY THE CIRCUIT PATH AND LOCATION, SIZE, AND QUANTITY OF THE CONDUITS THAT SPAN BETWEEN POLE TO
- 7. ALL FIXTURES TO HAVE A FLAT LENS UNLESS OTHERWISE SPECIFIED
- 8. UNLESS OTHERWISE SPECIFIED, THE LIGHTING MODEL HAS DEPICTED FOOT-CANDLE READINGS AT GROUND ELEVATION.

- 11. ALL FIXTURES, LAMPS, AND POLES SHALL BE INSPECTED AND MAINTAINED AS NECESSARY TO COMPLY WITH THE INTENT OF THE DESIGN DRAWINGS.
- 12. ALL LIGHT POLES AND FIXTURES SHALL BE BRONZE IN COLOR.
- 13. LED LIGHT FIXTURES SHALL BE EQUIPPED WITH LED CONTROLS TO ALLOW FULL ADJUSTMENT AND CONTROL OF THE LIGHT LEVELS IN ORDER TO MAKE FIELD ADJUSTMENTS AS NECESSARY



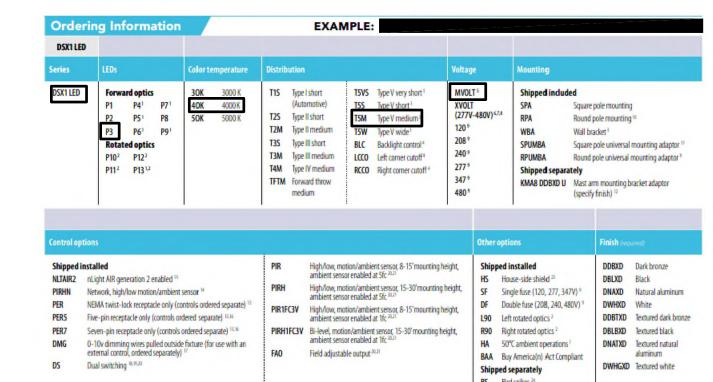

#### AREA LIGHT FIXTURE CUTSHEET DETAIL (FIXTURE B)

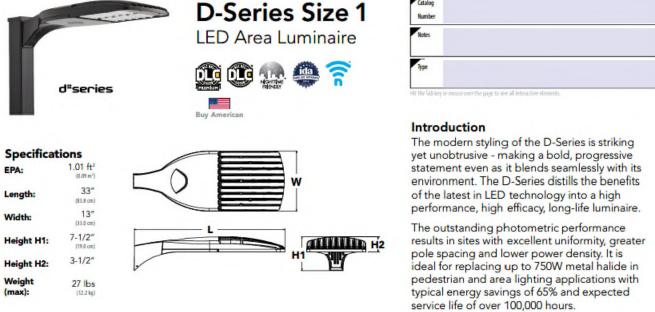

Orde	ring Information		EXAMPLE:		
DSX1 LE	ED				
Series	LEDs	Color temperature	Distribution Volta	age Mounting	
DSX1 LED	Forward optics P1 P4 P7 P2 P2 P5 P8 P3 P6 P9 P1 Rotated optics P10 P12 P13 P12 P11 P13 P13 P13 P13 P13 P13 P13 P13 P13	30K 3000 K 40K 4000 K 50K 5000 K	(Automotive) TSS Type V short 1 XVO	7V-480V) 67.8  P	e pole mounting if pole mounting is pole mounting is pole universal mounting adaptor is pole universal mounting adaptor is arm mounting bracket adaptor fy finish) is
Control op	otions			Other options	Finish (required)
Shippedi NLTAIR2 PIRHN PER PER5 PER7 DMG	installed  nLight AIR generation 2 enabled <sup>18</sup> Network, high/low motion/ambient is NEMA twist-lock receptade only (confrols or Seven-pin receptade only (controls or 0-10v dimming wires pulled outside external control, ordered separately) Dual switching <sup>18,19,10</sup>	ntrols ordered separate) 15 dered separate) 15,16 ordered separate) 15,16 e fixture (for use with an	PIR High/low, motion/ambient sensor, 8-15'mounting height, ambient sensor enabled at 5fc <sup>20,23</sup> PIRH High/low, motion/ambient sensor, 15-30'mounting height, ambient sensor enabled at 5fc <sup>20,23</sup> PIR1FC3V High/low, motion/ambient sensor, 8-15'mounting height, ambient sensor enabled at 1fc <sup>20,23</sup> PIRH1FC3V Bi-level, motion/ambient sensor, 15-30'mounting height, ambient sensor enabled at 1fc <sup>20,23</sup> FAO Field adjustable output <sup>20,23</sup>	Shipped installed HS House-side shield <sup>28</sup> SF Single fuse (120, 277, 347V) <sup>9</sup> DF Double fuse (208, 240, 480V) <sup>9</sup> L90 Left rotated optics <sup>2</sup> R90 Right rotated optics <sup>2</sup> HA 50°C ambient operations <sup>1</sup> BAA Buy America(n) Act Compliant Shipped separately BS Bird spikes <sup>24</sup>	DDBXD Dark bronze DBLXD Black DNAXD Natural aluminum DWHXD White DDBTXD Textured dark bronz DBLBXD Textured black DNATXD Textured natural aluminum DWHGXD Textured white

AREA LIGHT FIXTURE CUTSHEET DETAIL (FIXTURE A)

**PRELIMINAR** BS Bird spikes 14 T. F. PUGSLEY, Jr. NJ LICENSE No.43527

> SHEET TITLE: LIGHTING **PLAN**

North Star Design CIVIL & CONSULTING ENGINEERS

HONE: 908-968-3499 FAX: 908-968-32/361 ROUTE 31, BLDG E, SUITE 1404 FLEMINGTON, NEW JERSEY 08822 WWW.NORTHSTARDESIGNLLC.COM

SHEET NO.: 6 OF 13

7/20/22 NJH DESIGN DATE: DESIGNED BY: CHECKED BY: DRAWING SCALE: As Shown PROJECT #: 21-020SS01 CAD FILE: **ZONING DISTRIC** : H-C ZONE

**REVISION 1** 11/10/22

**Call** before you dig.

Know what's **below.** 

LUMINAIRE SCHEDULE SYMBOL LABEL QTY CATALOG NUMBER DESCRIPTION IES FILE LUMENS LLF DSX1 LED P3 40K DSX1 LED P3 40K TFTM MVOLT TFTM MVOLT \_40K\_TFTM\_ MVOLT.ies DSX1 LED P3 40K DSX1 LED P3 40K DSX1\_LED\_P3 Absolute 1.00 \_40K\_T5M\_ MVOLT.ies

THIS PLAN HAS BEEN PREPARED UTILIZING PHOTOMETRIC DATA PROVIDED BY THE MANUFACTURERS FOR THE INDIVIDUAL LIGHT FIXTURE(S) SPECIFIED. THIS DATA IS BASED ON LABORATORY ANALYSIS WHICH HAS BEEN TESTED PER THE REQUIREMENTS OF THE ILLUMINATING ENGINEERING SOCIETY OF NORTH AMERICA. ACTUAL FIELD CONDITIONS MAY VARY DUE TO ELECTRICAL SOURCE, FIXTURE TOLERANCES, ENVIRONMENTAL AND

SEE DETAIL SHEET C-1.6 (SHEET 8 OF 13) FOR LIGHT POLE BASE DETAIL

GRAPHIC SCALE ( IN FEET ) 1 inch = 20 ft.

COMPLIANCE REQUIREMENTS: (19A-2.7)

1.0 FOOTCANDLES (COMPLIES)

THE LIGHT INTENSITY PROVIDED AT GROUND LEVEL SHALL BE

AVERAGE NOT LESS THAN FIVE-TENTHS FOOTCANDLES AT

THAN ONE FOOTCANDLE THROUGHOUT THE AREA TO BE

INDICATED IN FOOTCANDLES ON THE SUBMITTED PLANS AND SHALL

INTERSECTIONS AND THREE-TENTHS FOOTCANDLES ELSEWHERE IN


PROPOSED: 0.3 FOOTCANDLES OR GREATER IS PROPOSED

WITHIN THE IMPROVEMENT AREA. 0.5 FOOTCANDLES OR GREATER

IS PROPOSED AT ALL ON-SITE INTERSECTIONS. WITH THE AREA OF

IMPROVEMENT, THE AVERAGE PROPOSED ILLUMINATION LEVEL IS

THE AREA TO BE ILLUMINATED. AND SHALL AVERAGE NOT MORE

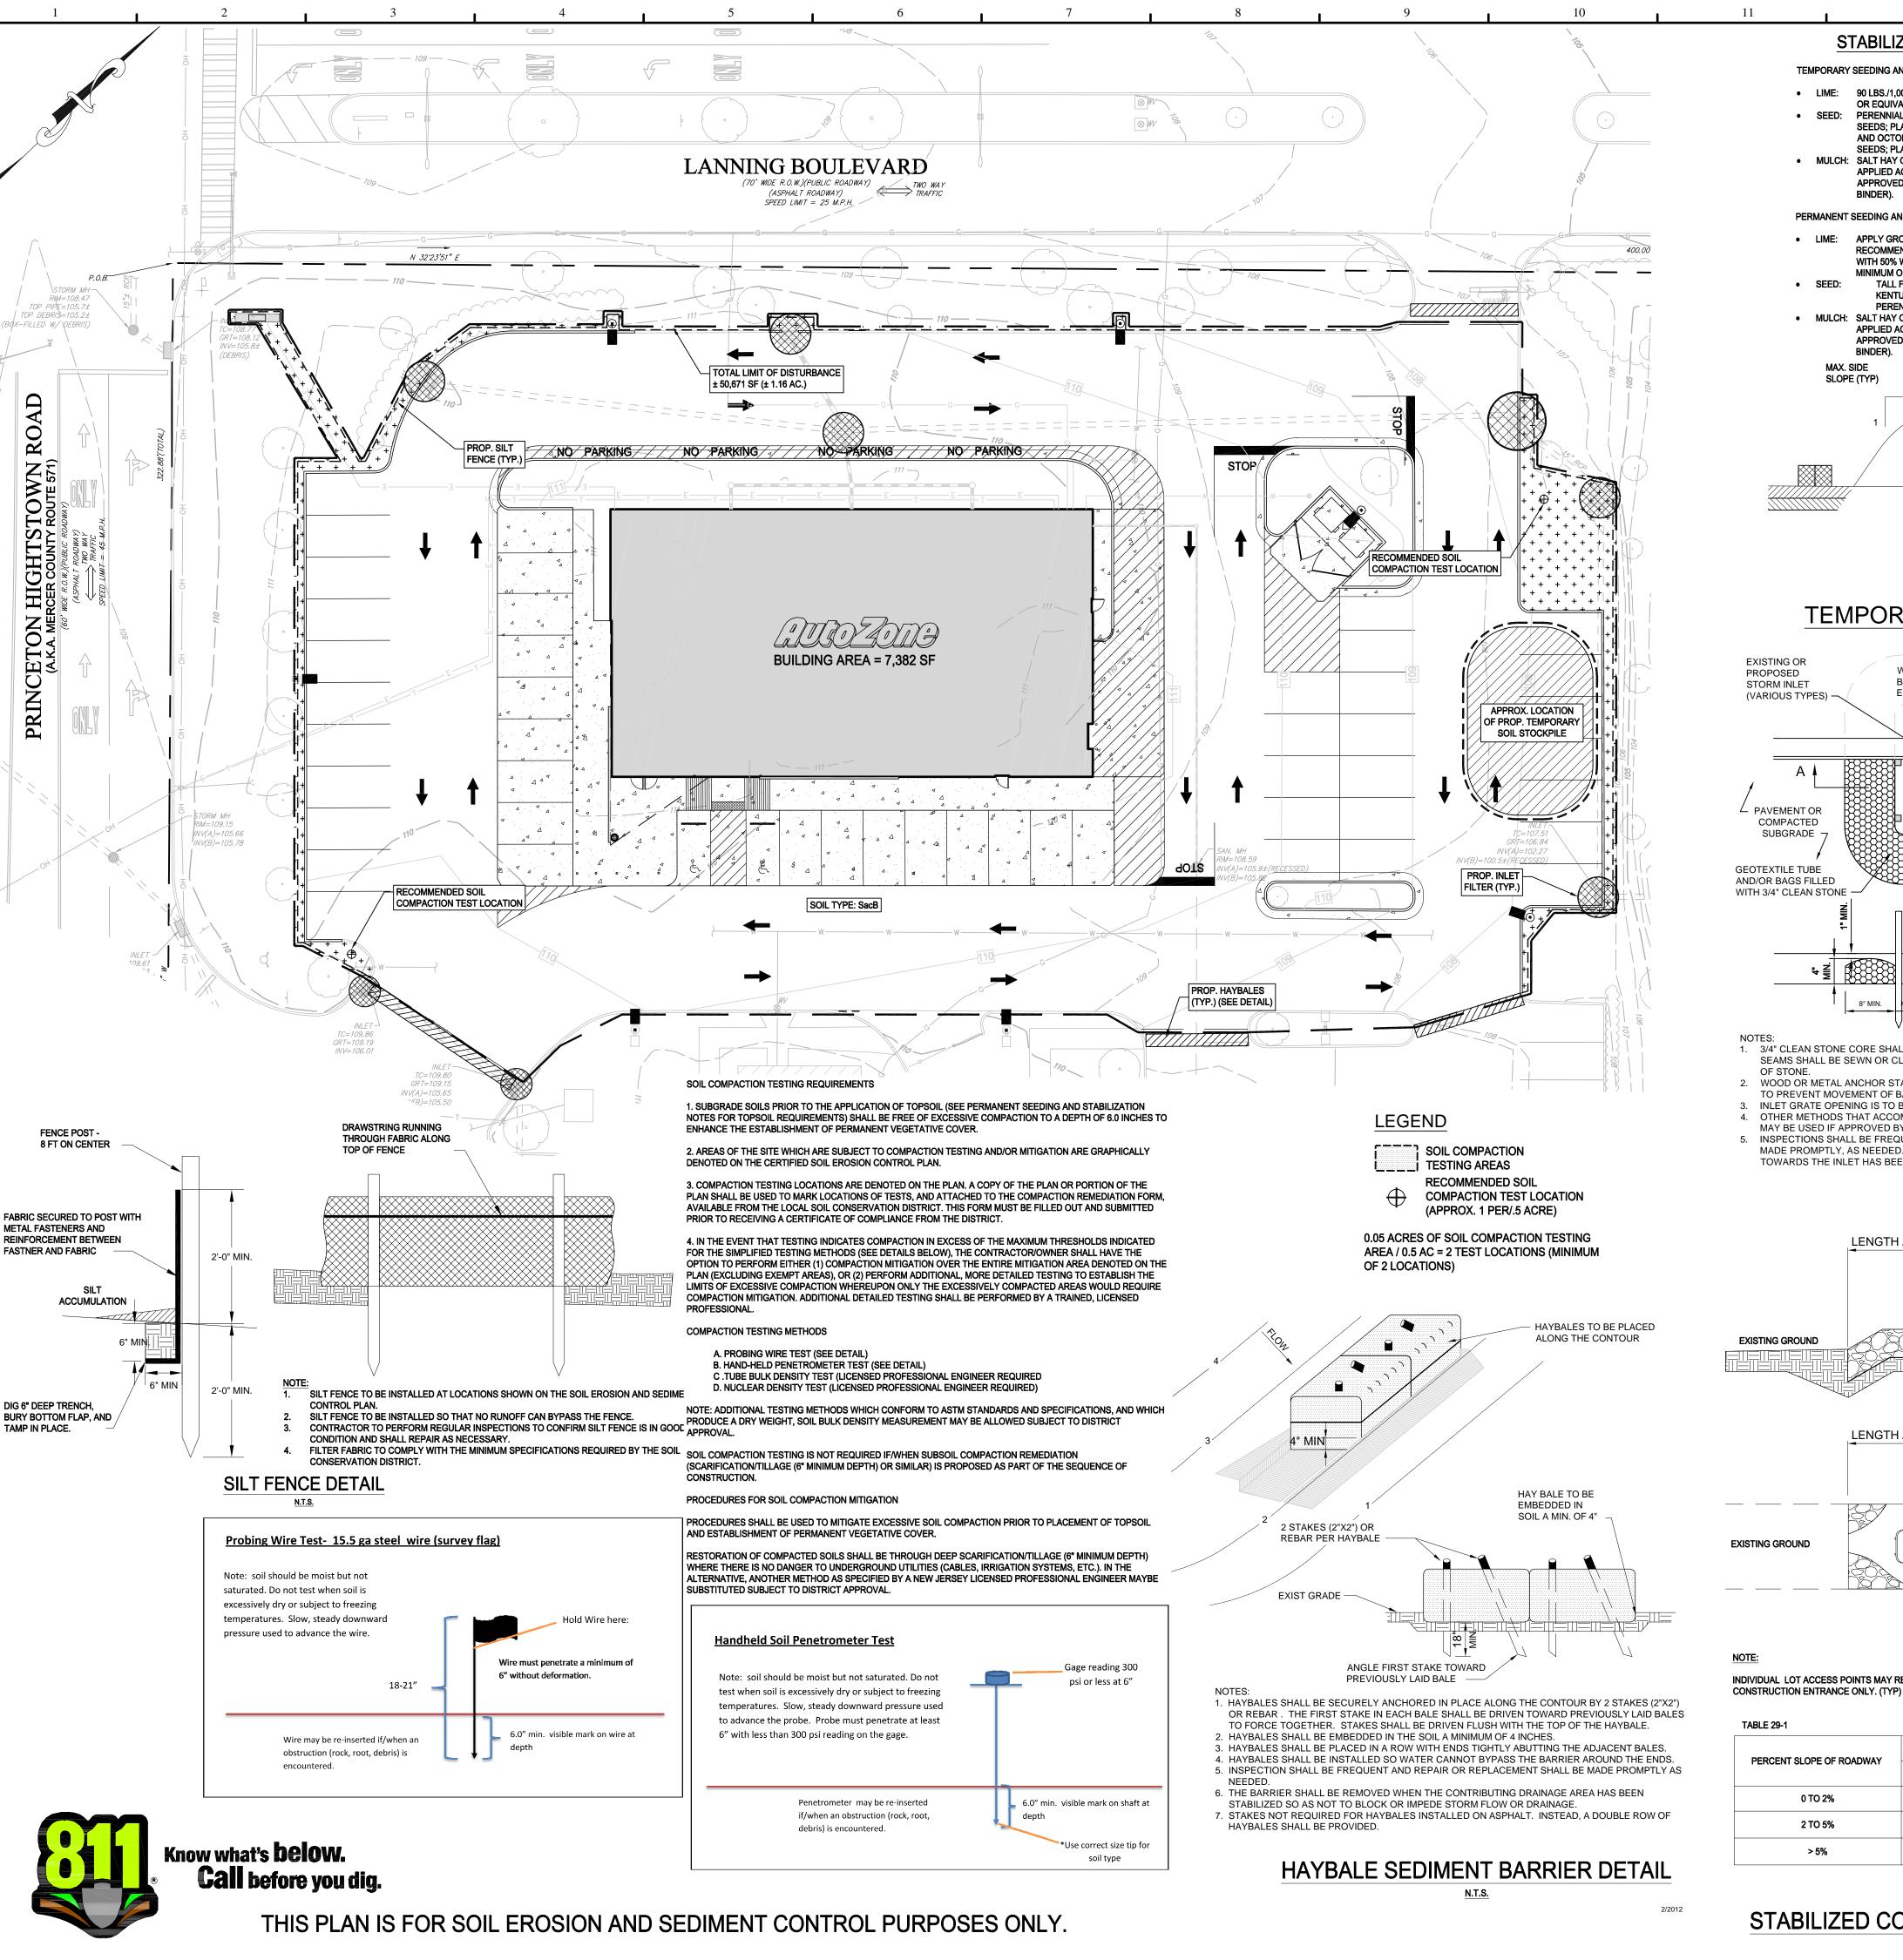


#### STABILIZATION SPECIFICATIONS:

#### TEMPORARY SEEDING AND MULCHING:

- LIME: 90 LBS./1,000 SF GROUND LIMESTONE; FERTILIZER 11 LBS./1,000 SF, 10-20-10 OR EQUIVALENT WORKED INTO THE SOIL A MINIMUM OF 4" SEED: PERENNIAL RYEGRASS 40 LBS./ACRE (1 LB./1.000 SF) OR OTHER APPROVED SEEDS; PLANT BETWEEN FEBRUARY 15 AND MAY 1 OR BETWEEN AUGUST 15
- AND OCTOBER 15. PEARL MILLET AT 20 LBS./ACRE OR OTHER APPROVED SEEDS; PLANT BETWEEN MAY 1 AND SEPTEMBER 1. MULCH: SALT HAY OR SMALL GRAIN STRAW AT A RATE OF 70 TO 90 LBS./1.000 SF TO BE APPLIED ACCORDING TO THE NJ STANDARDS. MULCH SHALL BE SECURED BY APPROVED METHODS (I.E. PEG AND TWINE, MULCH NETTING, OR LIQUID MULCH


#### PERMANENT SEEDING AND MULCHING:

- LIME: APPLY GROUND LIMESTONE AND FERTILIZER ACCORDING TO SOIL TEST RECOMMENDATIONS: FERTILIZER - 11 LBS./1.000 SF. 10-10-10 OR EQUIVALENT WITH 50% WATER INSOLUBLE NITROGEN INCORPORATED INTO THE SOIL A
- MINIMUM OF 4". 265 LBS/ACRE OR 6 LBS/1000 SF 20 LBS/ACRE OR 0.50 LBS/1.000 SF KENTUCKY BLUEGRASS (BLEND): PERENNIAL RYEGRASS (BLEND): 20 LBS/ACRE OR 0.50 LBS/1.000 SF MULCH: SALT HAY OR SMALL GRAIN STRAW AT A RATE OF 70 TO 90 LBS./1,000 SF TO BE
- APPLIED ACCORDING TO THE NJ STANDARDS. MULCH SHALL BE SECURED BY APPROVED METHODS (I.E. PEG AND TWINE, MULCH NETTING, OR LIQUID MULCH SLOPE (TYP

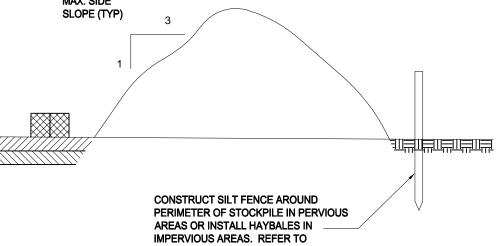


#### TEMPORARY STOCKPILE DETAIL

APPROPRIATE DETAIL (TYP.)

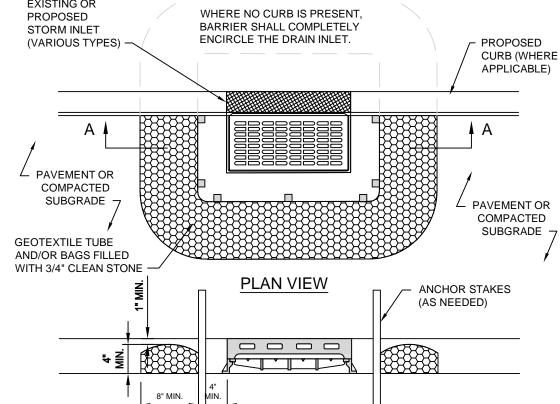

- 1. 3/4" CLEAN STONE CORE SHALL BE COMPLETELY CONTAINED WITHIN GEOTEXTILE FABRIC. ALL SEAMS SHALL BE SEWN OR CLOSED BY SUITABLE MECHANICAL MEANS TO PREVENT LEAKAGE
- 2. WOOD OR METAL ANCHOR STAKES SHALL BE INSTALLED AS REQUIRED BY FIELD CONDITIONS TO PREVENT MOVEMENT OF BARRIER.
- INLET GRATE OPENING IS TO BE KEPT CLEAR OF OBSTRUCTIONS AT ALL TIMES.
- OTHER METHODS THAT ACCOMPLISH THE PURPOSE OF THE STORM SEWER INLET PROTECTION MAY BE USED IF APPROVED BY THE LOCAL SOIL CONSERVATION DISTRICT.
- 5. INSPECTIONS SHALL BE FREQUENT. MAINTENANCE, REPAIR, AND REPLACEMENT SHALL BE MADE PROMPTLY, AS NEEDED. THE BARRIER SHALL BE REMOVED WHEN THE AREA DRAINING TOWARDS THE INLET HAS BEEN STABILIZED.

#### **INLET FILTER DETAIL**

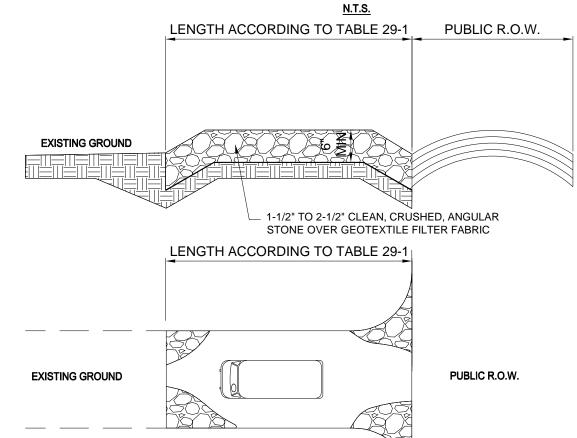

#### INDIVIDUAL LOT ACCESS POINTS MAY REQUIRE STABILIZATION. THICKNESS SHOWN IS FOR STONE

PERCENT SLOPE OF ROADWAY	LENGTH OF STONE REQUIRED		
PERCENT SLOPE OF ROADWAY	COARSE GRAINED SOILS	FINE GRAINED SOILS	
0 TO 2%	50 FT	100 FT	
2 TO 5%	100 FT	200 FT	
> 5%	ENTIRE SURFACE STABILIZED WITH FABC BASE COURSE		

#### MERCER COUNTY SOIL CONSERVATION DISTRICT SOIL EROSION AND SEDIMENT CONTROL NOTES:

- THE MERCER COUNTY SOIL CONSERVATION DISTRICT SHALL BE NOTIFIED 48 HOURS PRIOR TO STARTING LAND DISTURBANCE ACTIVITY, NOTICE MAY BE MAILED, FAXED OR EMAILED TO: MCSCD, 590 HUGHES DRIVE, HAMILTON SQUARE, NJ 08690 PHONE: 609-586-9603 FAX: 609-586-1117 EMAIL: PAULS1MERCER@AOL.COM
- IF APPLICABLE TO THIS PROJECT, THE OWNER SHOULD BE AWARE OF HIS OR HER OBLIGATION TO FILE FOR A NJPDES CONSTRUCTION ACTIVITY STORMWATER 5G3 PERMIT (NJG0088323) VIA THE NJDEP ONLINE PERMITTING SYSTEM (WWW.N.I.GOV/DEP/ONLINE) AND TO MAINTAIN THE ASSOCIATED BEST MANAGEMENT PRACTICES AND STORMWATER POLLUTION PREVENTION PLAN SELF-INSPECTION LOGBOOK ONSITE AT ALL TIMES. THIS PERMIT MUST BE FILED PRIOR TO THE START OF SOIL DISTURBANCE. THE ONLINE APPLICATION PROCESS WILL REQUIRE ENTRY OF AN SCD CERTIFICATION CODE, WHICH IS PROVIDED BY THE SOIL CONSERVATION DISTRICT UPON CERTIFICATION OF THE SOIL EROSION AND SEDIMENT CONTROL PLAN.
- 3. THE MERCER COUNTY SOIL CONSERVATION DISTRICT SHALL BE NOTIFIED OF ANY CHANGES IN OWNERSHIP. ANY CHANGES TO THE CERTIFIED SOIL EROSION AND SEDIMENT CONTROL PLAN. INCLUDING AN INCREASE IN THE LIMIT OF DISTURBANCE, WILL REQUIRE THE SUBMISSION OF REVISED SOIL EROSION AND SEDIMENT CONTROL PLANS TO THE DISTRICT FOR RECERTIFICATION, THE REVISED PLANS MUST MEET ALL CURRENT STATE SOIL EROSION & SEDIMENT
- A COPY OF THE CERTIFIED SOIL EROSION AND SEDIMENT CONTROL PLAN SHALL BE MAINTAINED ON SITE AT ALL TIMES. ALL SOIL EROSION AND SEDIMENT CONTROL PRACTICES SHALL BE INSTALLED PRIOR TO ANY MAJOR SOIL
- DISTURBANCES, OR IN THEIR PROPER SEQUENCE AS OUTLINED WITHIN THE SEQUENCE OF CONSTRUCTION ON THE CERTIFIED SOIL EROSION AND SEDIMENT CONTROL PLAN, AND MAINTAINED UNTIL PERMANENT PROTECTION IS
- ALL WORK SHALL BE DONE IN ACCORDANCE WITH THE CURRENT STANDARDS FOR SOIL EROSION AND SEDIMENT CONTROL IN NJ. IF LANGUAGE CONTAINED WITHIN ANY OTHER PERMIT FOR THIS PROJECT IS MORE RESTRICTIVE T (BUT NOT CONTRADICTORY TO) WHAT IS CONTAINED WITHIN THESE NOTES OR ON THE CERTIFIED SOIL EROSION AND SEDIMENT CONTROL PLAN. THEN THE MORE RESTRICTIVE PERMIT REQUIREMENTS SHALL BE FOLLOWED
- THE STANDARD FOR STABILIZED CONSTRUCTION ACCESS REQUIRES THE INSTALLATION OF A 11/2" TO 21/2" CLEAN STONE TRACKING PAD AT ALL CONSTRUCTION DRIVEWAYS IMMEDIATELY AFTER INITIAL SITE DISTURBANCE, WHETHER IDENTIFIED ON THE CERTIFIED PLAN OR NOT. THE WIDTH SHALL SPAN THE FULL WIDTH OF EGRESS, AND LENGTH SH BE 50 FT, OR MORE, DEPENDING ON SITE CONDITIONS AND AS REQUIRED BY THE STANDARD, THIS SHALL INCLUDE INDIVIDUAL LOT ACCESS POINTS WITHIN RESIDENTIAL SUBDIVISIONS IF THE EGRESS IS TO A COUNTY ROAD. THEN A 20 FT. LONG PAVED TRANSITION SHALL BE PROVIDED BETWEEN THE EDGE OF PAVEMENT AND THE STONE ACCESS PAD.
- A SUB-BASE COURSE WILL BE APPLIED IMMEDIATELY FOLLOWING ROUGH GRADING AND INSTALLATION OF IMPROVEMENTS IN ORDER TO STABILIZE STREETS, ROADS, DRIVEWAYS AND PARKING AREAS, IN AREAS WHERE NO UTILITIES ARE PRESENT. THE SUB-BASE SHALL BE INSTALLED WITHIN 15 DAYS OF PRELIMINARY GRADING. PROVIDED THAT ALL OTHER REQUIREMENTS RELATED TO DETENTION BASINS, SWALES AND THE SEQUENCE OF CONSTRUCTION
- ANY DISTURBED AREAS THAT WILL BE LEFT EXPOSED MORE THAN 14 DAYS AND NOT SUBJECT TO CONSTRUCTION ACTIVITY WILL IMMEDIATELY RECEIVE TEMPORARY STABILIZATION. IF THE SEASON PREVENTS ESTABLISHMENT OF A TEMPORARY VEGETATIVE COVER, OR IF THE AREA IS NOT TOPSOILED, THEN THE DISTURBED AREAS WILL BE MULCHED WITH STRAW, OR EQUIVALENT MATERIAL, AT A RATE OF TWO (2) TONS PER ACRE, ACCORDING TO STATE STANDARDS. SLOPED AREAS IN EXCESS OF 3H:1V SHALL BE PROVIDED WITH EROSION CONTROL BLANKETS. CRITICAL AREAS SUBJECT TO EROSION (I.E. STEEP SLOPES, ROADWAY EMBANKMENTS, ENVIRONMENTALLY SENSITIVE AREAS) WILL RECEIVE TEMPORARY STABILIZATION IMMEDIATELY AFTER AN INITIAL DISTURBANCE OR ROUGH GRADING
- ANY STEEP SLOPES (I.E. SLOPES GREATER THAN 3:1) RECEIVING PIPELINE OR UTILITY INSTALLATION WILL BE BACKFILLED AND STABILIZED DAILY, AS THE INSTALLATION PROCEEDS.
- GRADING AND TOPSOILING. ALL AGRONOMIC REQUIREMENTS CONTAINED WITHIN THE STANDARDS AND ON THE CERTIFIED PLAN SHALL BE EMPLOYED. MULCH WITH A BINDER, IN ACCORDANCE WITH THE STANDARDS, SHALL BE USED ON ALL SEEDED AREAS. SAVE ALL TAGS AND/OR BAGS USED FOR SEED, LIME, AND FERTILIZER, AND PROVIDE THEM TO THE DISTRICT INSPECTOR TO VERIFY THAT MIXTURES AND RATES MEET THE STANDARDS AT THE TIME WHEN THE SITE PREPARATION FOR PERMANENT VEGETATIVE STABILIZATION IS GOING TO BE

PERMANENT VEGETATION SHALL BE SEEDED OR SODDED ON ALL EXPOSED AREAS WITHIN TEN (10) DAYS AFTER FINAL

- ACCOMPLISHED, ANY SOIL THAT WILL NOT PROVIDE A SUITABLE ENVIRONMENT TO SUPPORT ADEQUATE VEGETATIVE GROLIND COVER SHALL BE REMOVED OR TREATED IN SUCH A WAY THAT WILL PERMANENTLY ADJUST THE SOIL CONDITIONS AND RENDER IT SUITABLE FOR VEGETATIVE GROUND COVER. IF THE REMOVAL OR TREATMENT OF THE SOIL WILL NOT PROVIDE SUITABLE CONDITIONS. THEN NON-VEGETATIVE MEANS OF PERMANENT GROUND
- DURING THE COURSE OF CONSTRUCTION, SOIL COMPACTION MAY OCCUR WITHIN HAUL ROUTES, STAGING AREAS, AND OTHER PROJECT AREAS, IN ACCORDANCE WITH THE STANDARD FOR TOPSOILING, COMPACTED SURFACES SHOULD BE SCARIFIED 6" TO 12" IMMEDIATELY PRIOR TO TOPSOIL APPLICATION. THIS WILL HELP ENSURE A GOOD BOND BETWEEN THE TOPSOIL AND SUBSOIL. THIS PRACTICE IS PERMISSIBLE ONLY WHERE THERE IS NO DANGER TO UNDERGROUND UTILITIES (CABLES, IRRIGATION SYSTEMS, ETC.).
- PRIOR TO SEEDING, TOPSOIL SHALL BE WORKED TO PREPARE A PROPER SEEDBED. THIS SHALL INCLUDE RAKING OF THE TOPSOIL AND REMOVAL OF DEBRIS AND STONES, ALONG WITH OTHER REQUIREMENTS OF THE STANDARD FOR
- IN ACCORDANCE WITH THE STANDARD FOR MANAGEMENT OF HIGH ACID PRODUCING SOILS. ANY SOIL HAVING A PH OF 4 OR LESS OR CONTAINING IRON SULFIDES SHALL BE BURIED WITH LIMESTONE IN ACCORDANCE WITH THE STANDARI AND BE COVERED WITH A MINIMUM OF 12" OF SOIL HAVING A PH OF 5 OR MORE PRIOR TO TOPSOIL APPLICATION AND SEEDBED PREPARATION. IF THE AREA IS TO RECEIVE TREE OR SHRUB PLANTINGS OR IS LOCATED ON A SLOPE, THEN THE AREA SHALL BE COVERED WITH A MINIMUM OF 24" OF SOIL HAVING A PH OF 5 OR MORE.
- MULCHING TO THE STANDARDS IS REQUIRED FOR OBTAINING A CONDITIONAL REPORT OF COMPLIANCE, CONDITIONAL ROC'S ARE ONLY ISSUED WHEN THE SEASON PROHIBITS SEEDING. PERMANENT STABILIZATION MUST THEN BE COMPLETED DURING THE OPTIMUM SEEDING SEASON IMMEDIATELY FOLLOWING THE CONDITIONAL ROC OR THE
- HYDROSEEDING IS A TWO-STEP PROCESS. THE FIRST STEP INCLUDES SEED, FERTILIZER, LIME, ETC., ALONG WITH MINIMAL AMOUNTS OF MULCH TO PROMOTE CONSISTENCY, GOOD SEED-TO-SOIL CONTACT, AND GIVE A VISUAL INDICATION OF COVERAGE. UPON COMPLETION OF THE SEEDING OPERATION, HYDRO-MULCH SHOULD BE APPLIED AT A MINIMUM RATE OF 1500 LBS. PER ACRE IN THE SECOND STEP. THE USE OF HYDRO-MULCH, AS OPPOSED TO STRAW, IS LIMITED TO OPTIMUM SEEDING DATES AS LISTED IN THE STANDARDS. THE USE OF HYDROMULCH ON SLOPED AREAS IS
- CONSTRUCTION PROJECT. ALL SEDIMENT WASHED, DROPPED, TRACKED OR SPILLED ONTO PAVED SURFACES SHALL I
- THE DEVELOPER SHALL BE RESPONSIBLE FOR REMEDIATING ANY EROSION OR SEDIMENT PROBLEMS THAT ARISE AS RESULT OF ONGOING CONSTRUCTION, AND FOR EMPLOYING ADDITIONAL EROSION AND SEDIMENT CONTROL MEASURES AT THE REQUEST OF THE MERCER COUNTY SOIL CONSERVATION DISTRICT.
- 21. CONDUIT OUTLET PROTECTION MUST BE INSTALLED AT ALL REQUIRED OUTFALLS PRIOR TO THE DRAINAGE SYSTEM
- ALL DETENTION / RETENTION BASINS MUST BE FULLY CONSTRUCTED (INCLUSIVE OF ALL STRUCTURAL COMPONENTS AND LINERS) AND PERMANENTLY STABILIZED PRIOR TO PAVING OR PRIOR TO THE ADDITION OF ANY IMPERVIOUS SURFACES, PERMANENT STABILIZATION INCLUDES, BUT MAY NOT BE LIMITED TO: TOPSOIL, SEED, STRAW MULCH AND BINDERS OR EROSION CONTROL BLANKETS ON ALL SEEDING, ALL AGRONOMIC REQUIREMENTS AS SPECIFIED ON THE CERTIFIED SOIL EROSION AND SEDIMENT CONTROL PLAN, INSTALLATION OF THE OUTFLOW CONTROL STRUCTURES AND DISCHARGE STORM DRAINAGE PIPING, LOW FLOW CHANNELS, CONDUIT OUTLET PROTECTION, EMERGENCY SPILLWAYS, AND LAP RING PROTECTION.
- 23. THE RIDING SURFACE OF ALL UTILITY TRENCHES WITHIN PAVED AREAS SHALL BE 3/4" CLEAN STONE OR BASE PAVEMENT UNTIL SUCH TIME AS FINAL PAVEMENT HAS BEEN INSTALLED. TEMPORARY SOIL RIDING SURFACES ARE
- ALL CONSTRUCTION DEWATERING (TRENCHES, EXCAVATIONS, ETC.) MUST BE DONE THROUGH AN INLET OR OUTLET FILTER IN ACCORDANCE WITH THE STANDARD FOR DEWATERING OR AS DEPICTED ON THE CERTIFIED SOIL EROSION AND SEDIMENT CONTROL PLAN. DISCHARGE LOCATIONS FOR THE DEWATERING OPERATION MUST CONTAIN PERENN
- 24 ALL CONSTRUCTION DEWATERING (TRENCHES EXCAVATIONS ETC.) MUST BE DONE THROUGH AN INLET OR QUITLET. FILTER IN ACCORDANCE WITH THE STANDARD FOR DEWATERING OR AS DEPICTED ON THE CERTIFIED SOIL EROSION AND SEDIMENT CONTROL PLAN. DISCHARGE LOCATIONS FOR THE DEWATERING OPERATION MUST CONTAIN PERI VEGETATION OR SIMILAR STABLE SURFACE
- ALL SWALES OR CHANNELS THAT WILL RECEIVE RUNOFF FROM PAVED SURFACES MUST BE PERMANENTLY STABILIZED PRIOR TO THE INSTALLATION OF PAVEMENT. IF THE SEASON PROHIBITS THE ESTABLISHMENT OF PERMANENT
- 26. NJSA 4:24-39 ET SEQ. REQUIRES THAT NO CERTIFICATE OF OCCUPANCY OR TEMPORARY CERTIFICATE OF OCCUPANCY BE ISSUED BY THE MUNICIPALITY BEFORE THE PROVISIONS OF THE CERTIFIED SOIL EROSION AND SEDIMENT CONTROL PLAN HAVE BEEN SATISFIED. THEREFORE, ALL SITE WORK FOR SITE PLANS AND ALL WORK AROUND INDIVIDUAL LOTS IN SUBDIVISIONS MUST BE COMPLETED BEFORE THE DISTRICT ISSUES A REPORT OF COMPLIANCE OR CONDITIONAL REPORT OF COMPLIANCE, WHICH MUST BE FORWARDED TO THE MUNICIPALITY PRIOR TO THE ISSUANCE OF A CERTIFICATE OF OCCUPANCY OR TEMPORARY CERTIFICATE OF OCCUPANCY, RESPECTIVELY. MERCER COUNTY SOIL CONSERVATION DISTRICT

#### **SEQUENCE OF CONSTRUCTION:**

- INSTALL STONE ANTI-TRACKING PAD AND OTHER SOIL EROSION AND SEDIMENT CONTROL MEASURES DEPICTED ON PLAN. (3 DAYS)
- DEMOLITION OF EXISTING BUILDING/ASPHALT AS NECESSARY. CLEAR SITE AND ROUGH GRADE FOR PROPOSED IMPROVEMENTS. (1 WEEK)
- PHASE 3: EXCAVATE AND INSTALL SANITARY AND STORM PIPING AND STRUCTURES
- AND ON-SITE UTILITIES. (1 WEEK) PHASE 4: EXCAVATE FOR BUILDING FOUNDATIONS. (1 WEEK)
- INSTALL SITE IMPROVEMENTS INCLUDING BUILDING FOUNDATION, CURBING AND OTHER SITE FEATURES. (3 WEEKS)
- PHASE 6: COMPLETE BUILDING CONSTRUCTION (12 WEEKS)
- FINAL GRADE ON SITE (1 WEEK)

HAMILTON SQUARE, N.J. 08690

- PHASE 8: INSTALL PAVING, CONCRETE, AND FINAL VEGETATION. (1 WEEK)
- REMOVE ALL SOIL EROSION AND SEDIMENT CONTROL MEASURES ONCE SITE IS STABILIZED. (3 DAYS)

GRAPHIC SCALE

( IN FEET 1 inch = 20 ft.

NJ LICENSE No.43527 SHEET TITLE: SOIL EROSION AND SEDIMENT **CONTROL PLAN** 

 $\vdash$ 

IONE: 908-968-3499 FAX: 908-968-32 361 ROUTE 31, BLDG E, SUITE 1404 FLEMINGTON, NEW JERSEY 08822 VWW.NORTHSTARDESIGNLLC.COM

OrthStarDesign


SHEET NO .: 7 OF 13


7/20/22 **DESIGNED BY:** CHECKED BY: DRAWING SCALE: As Shown PROJECT #: 21-020 CAD FILE: 21-020SS01


ZONING DISTRIC **H-C ZONE REVISION 1** 


11/10/22


STABILIZED CONSTRUCTION ACCESS DETAIL (IF REQUIRED)

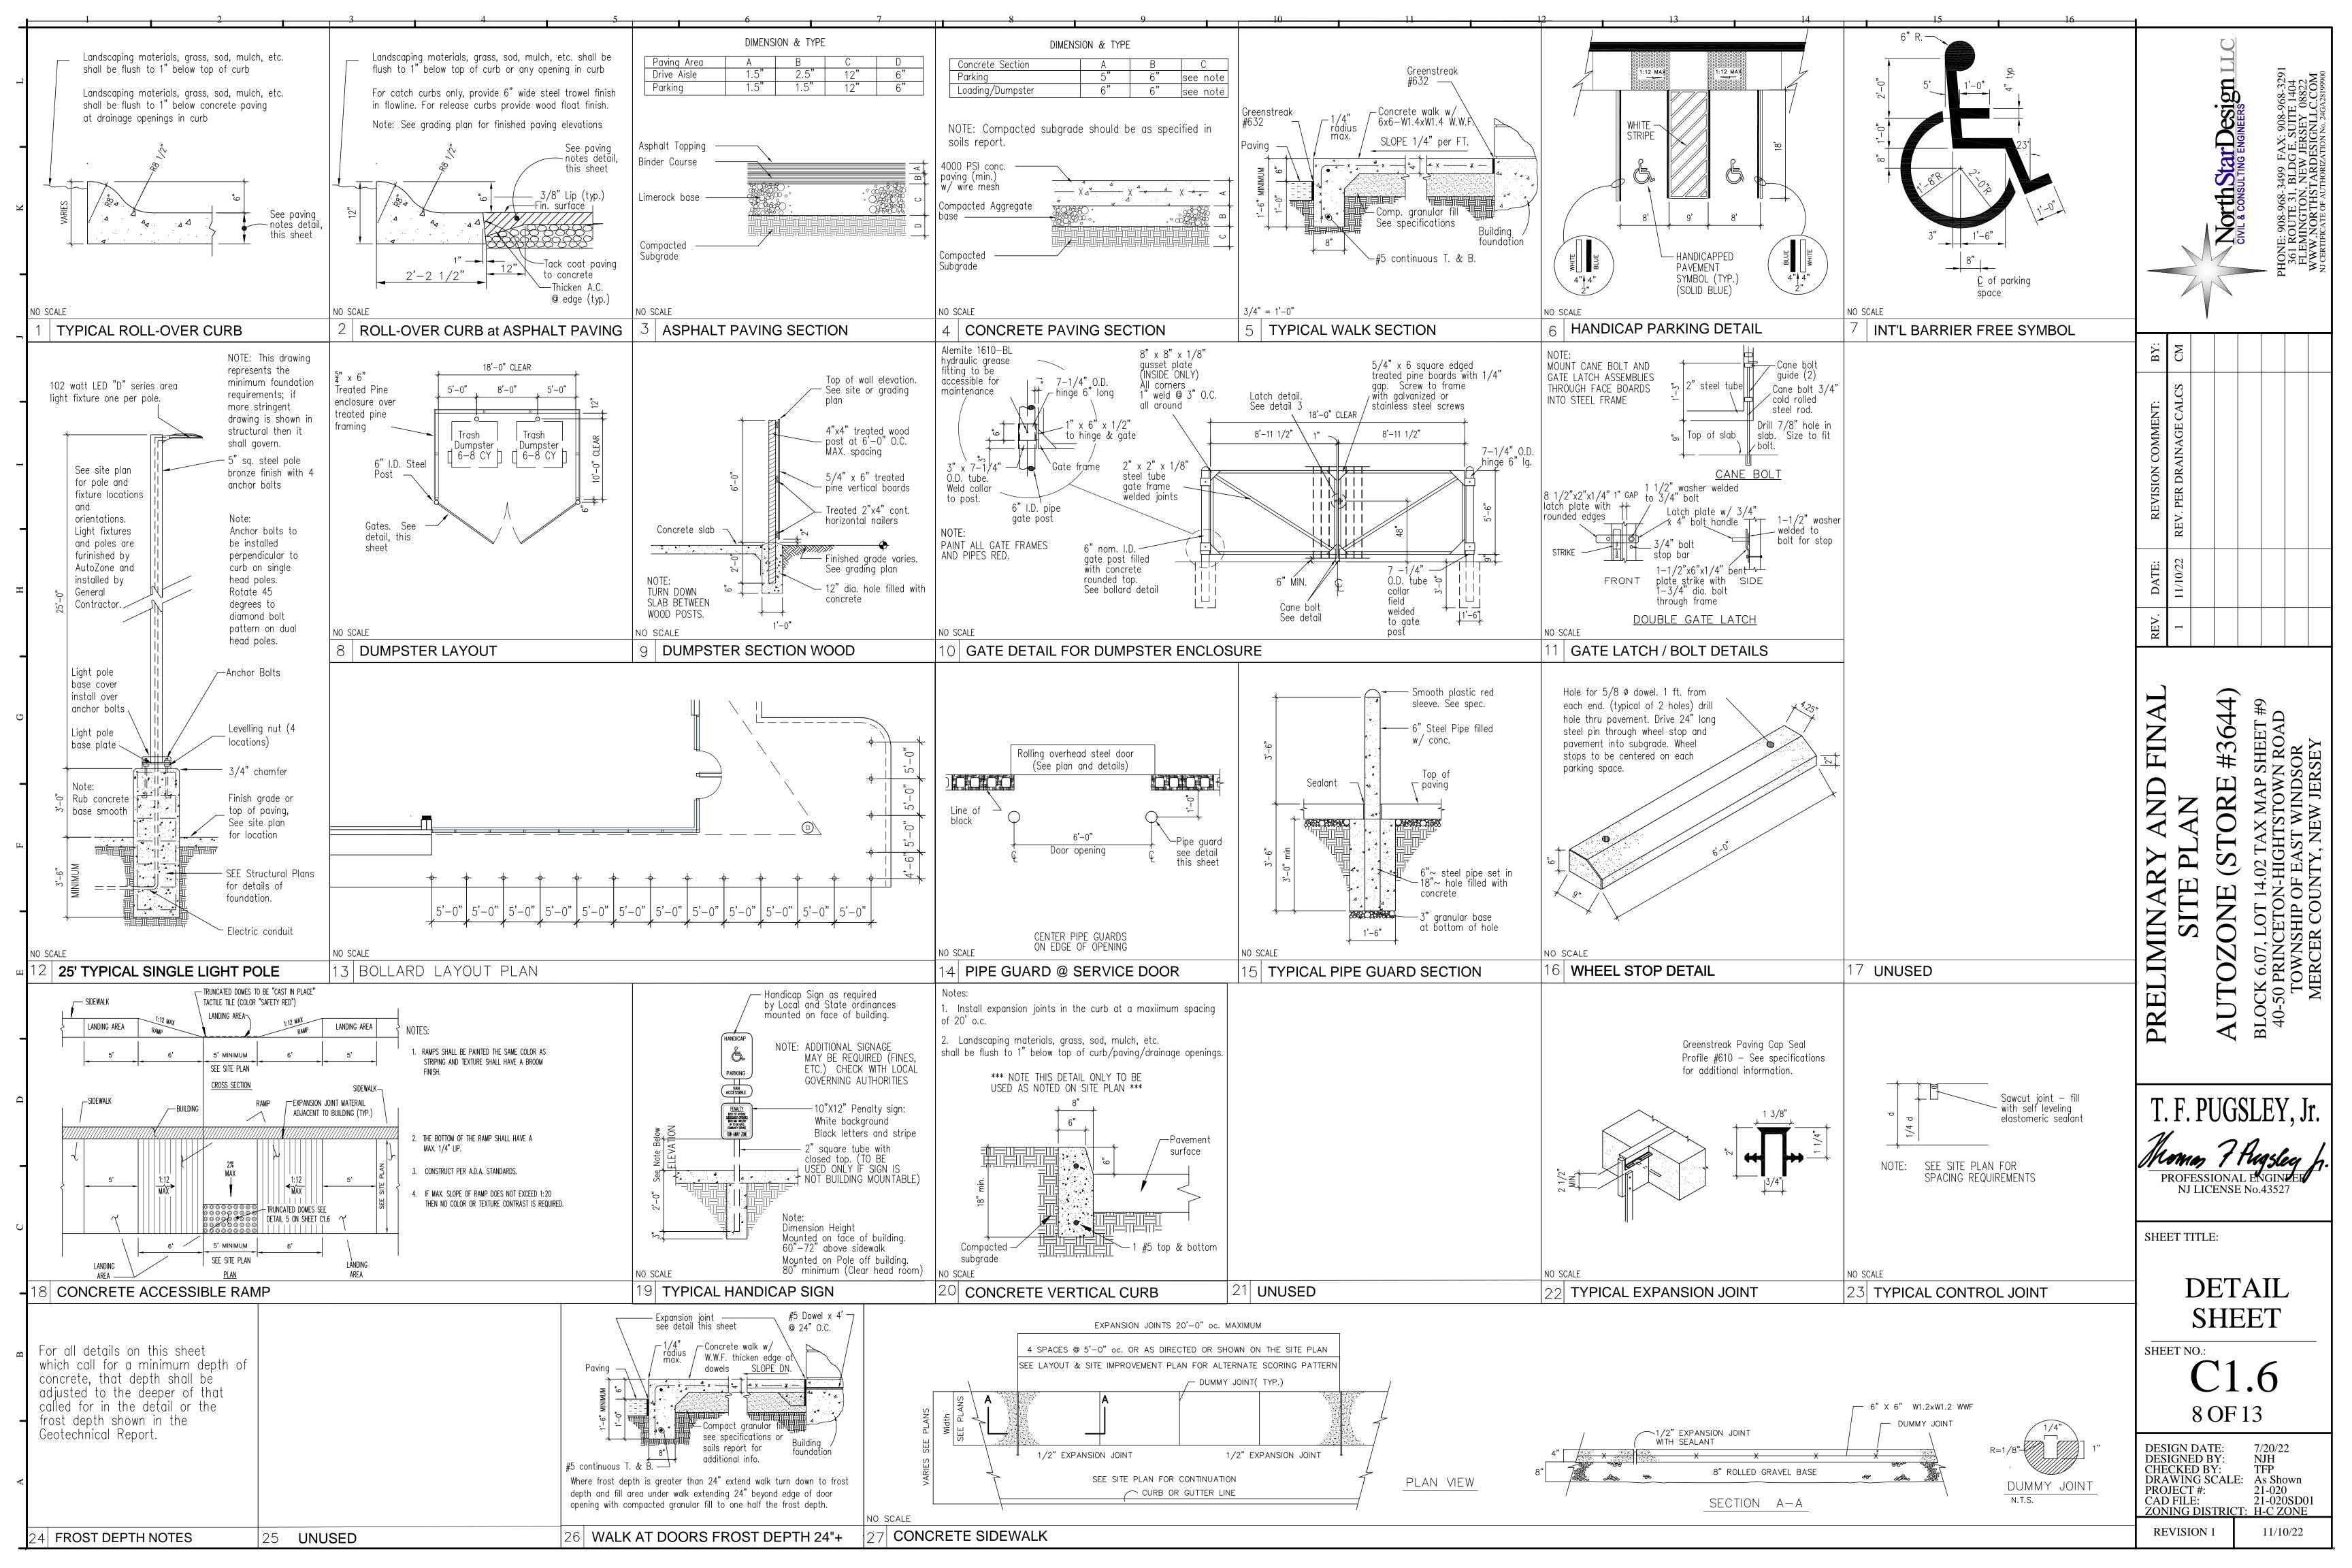

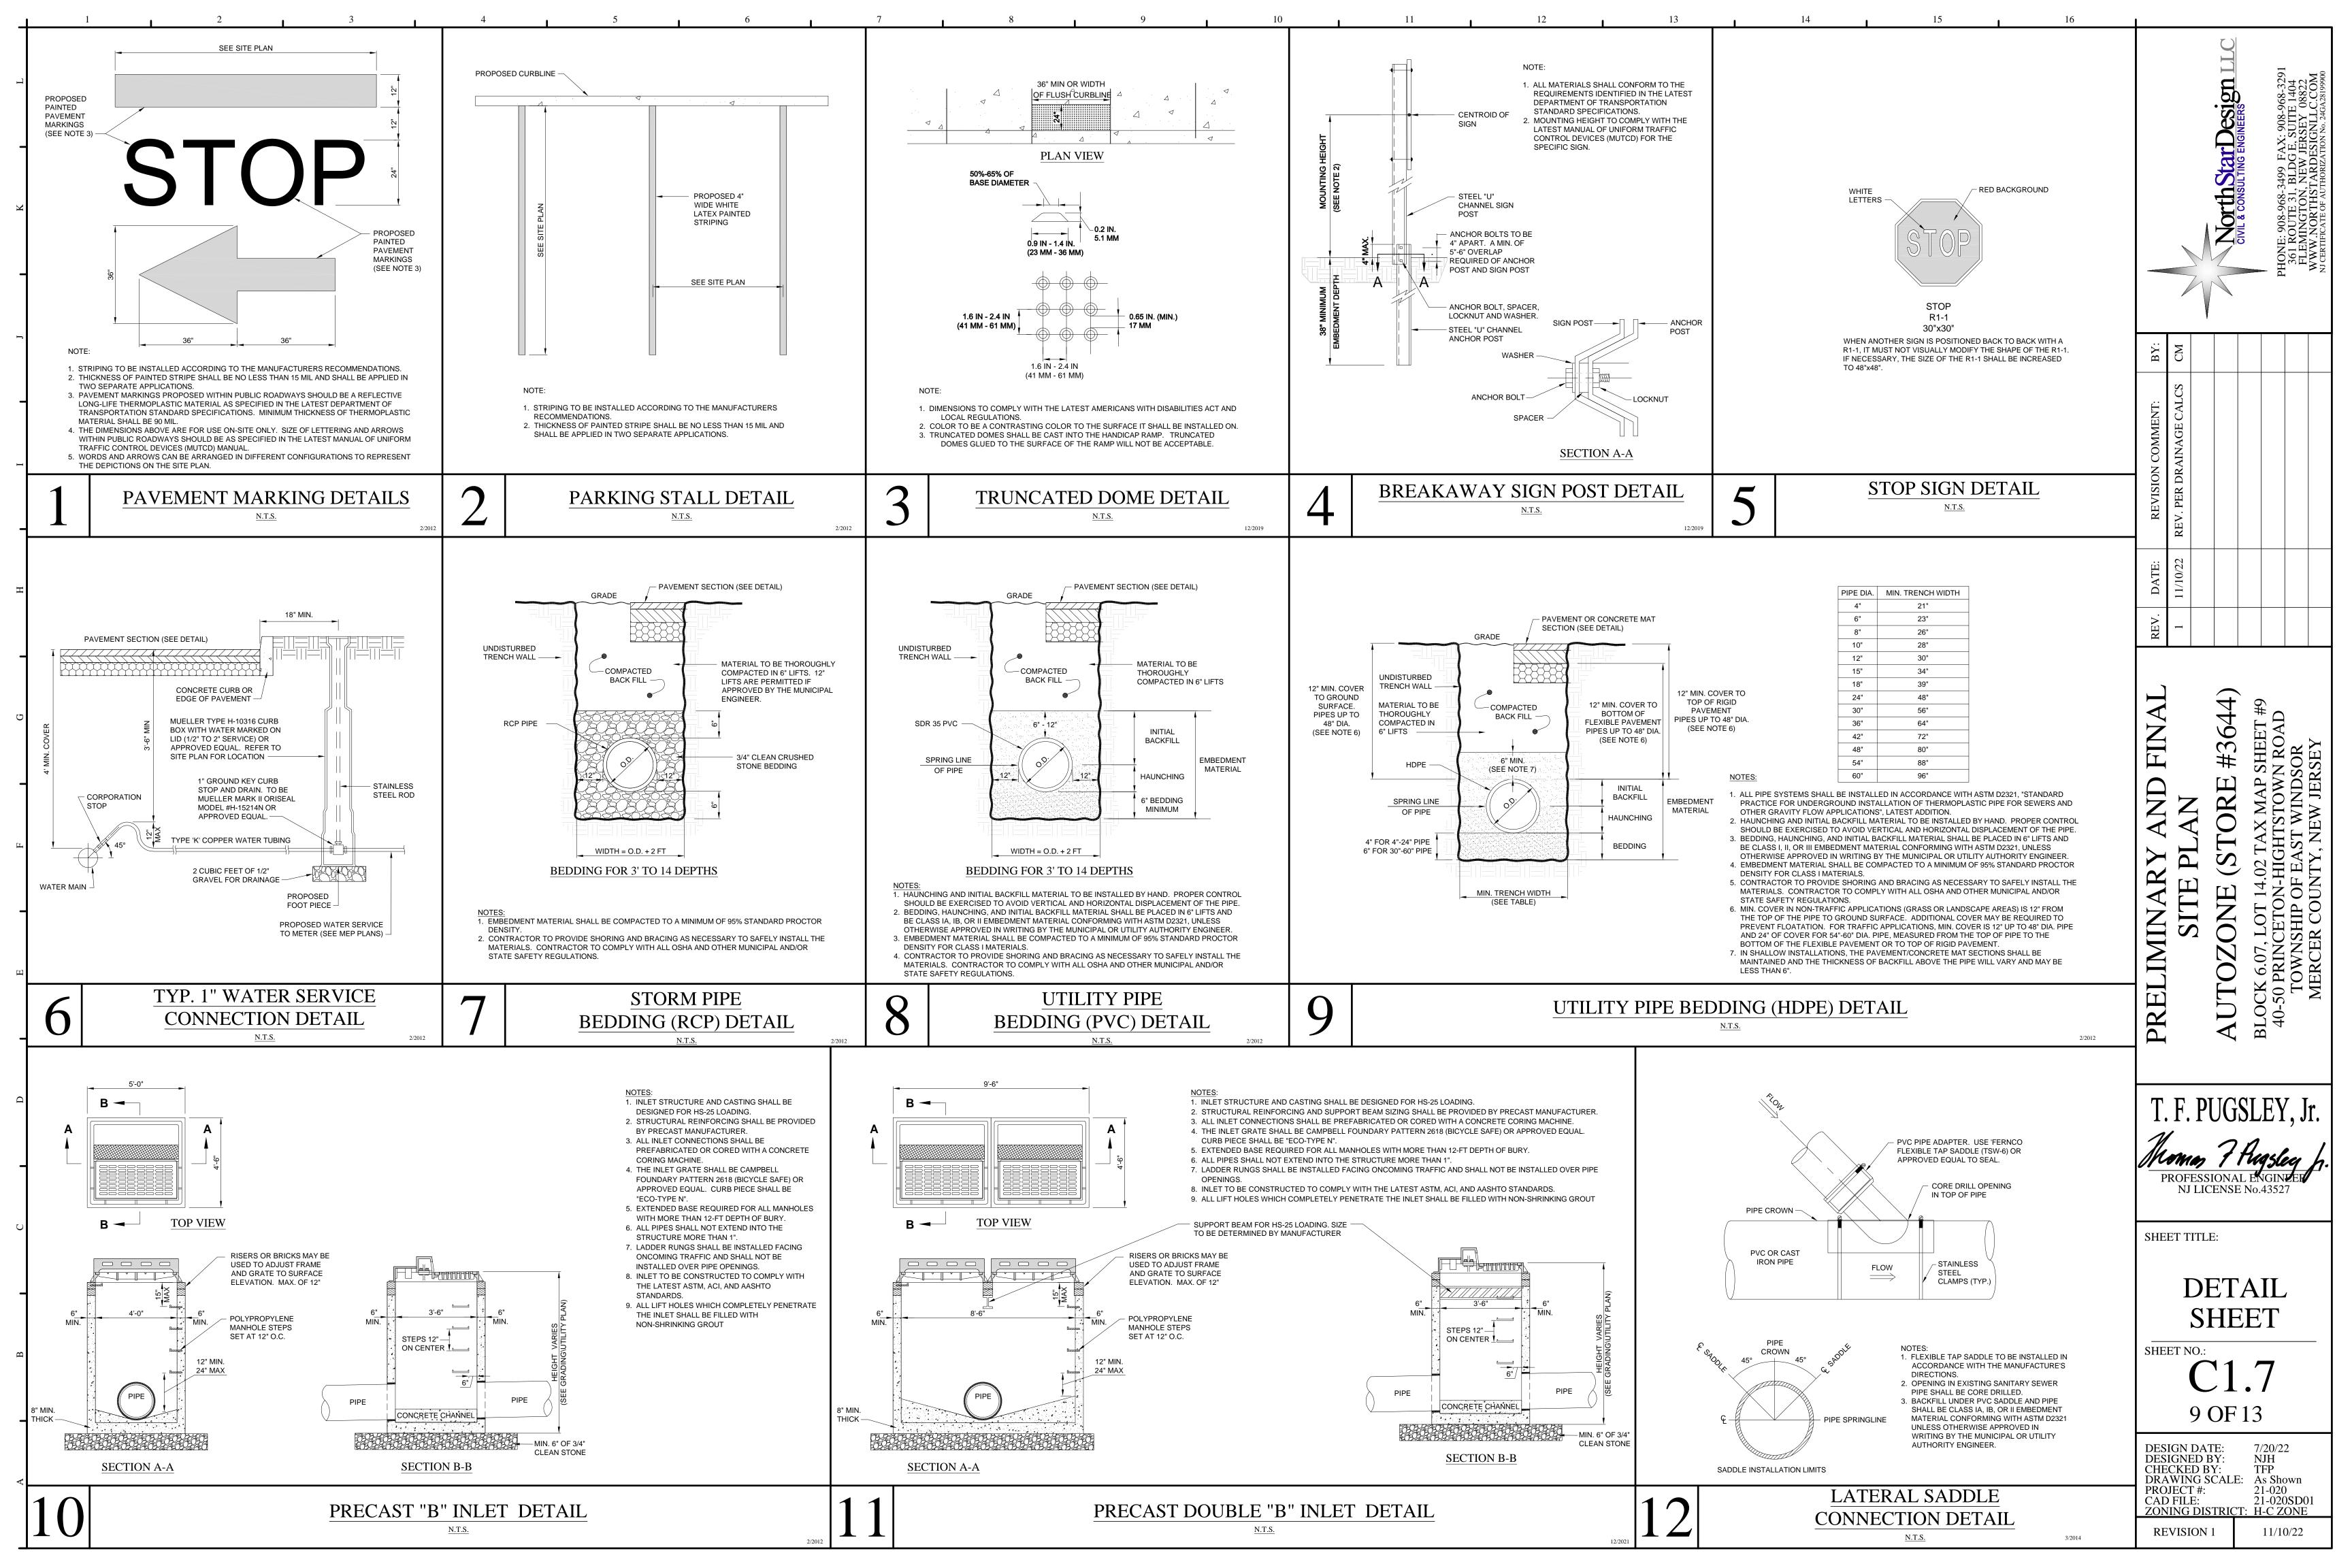

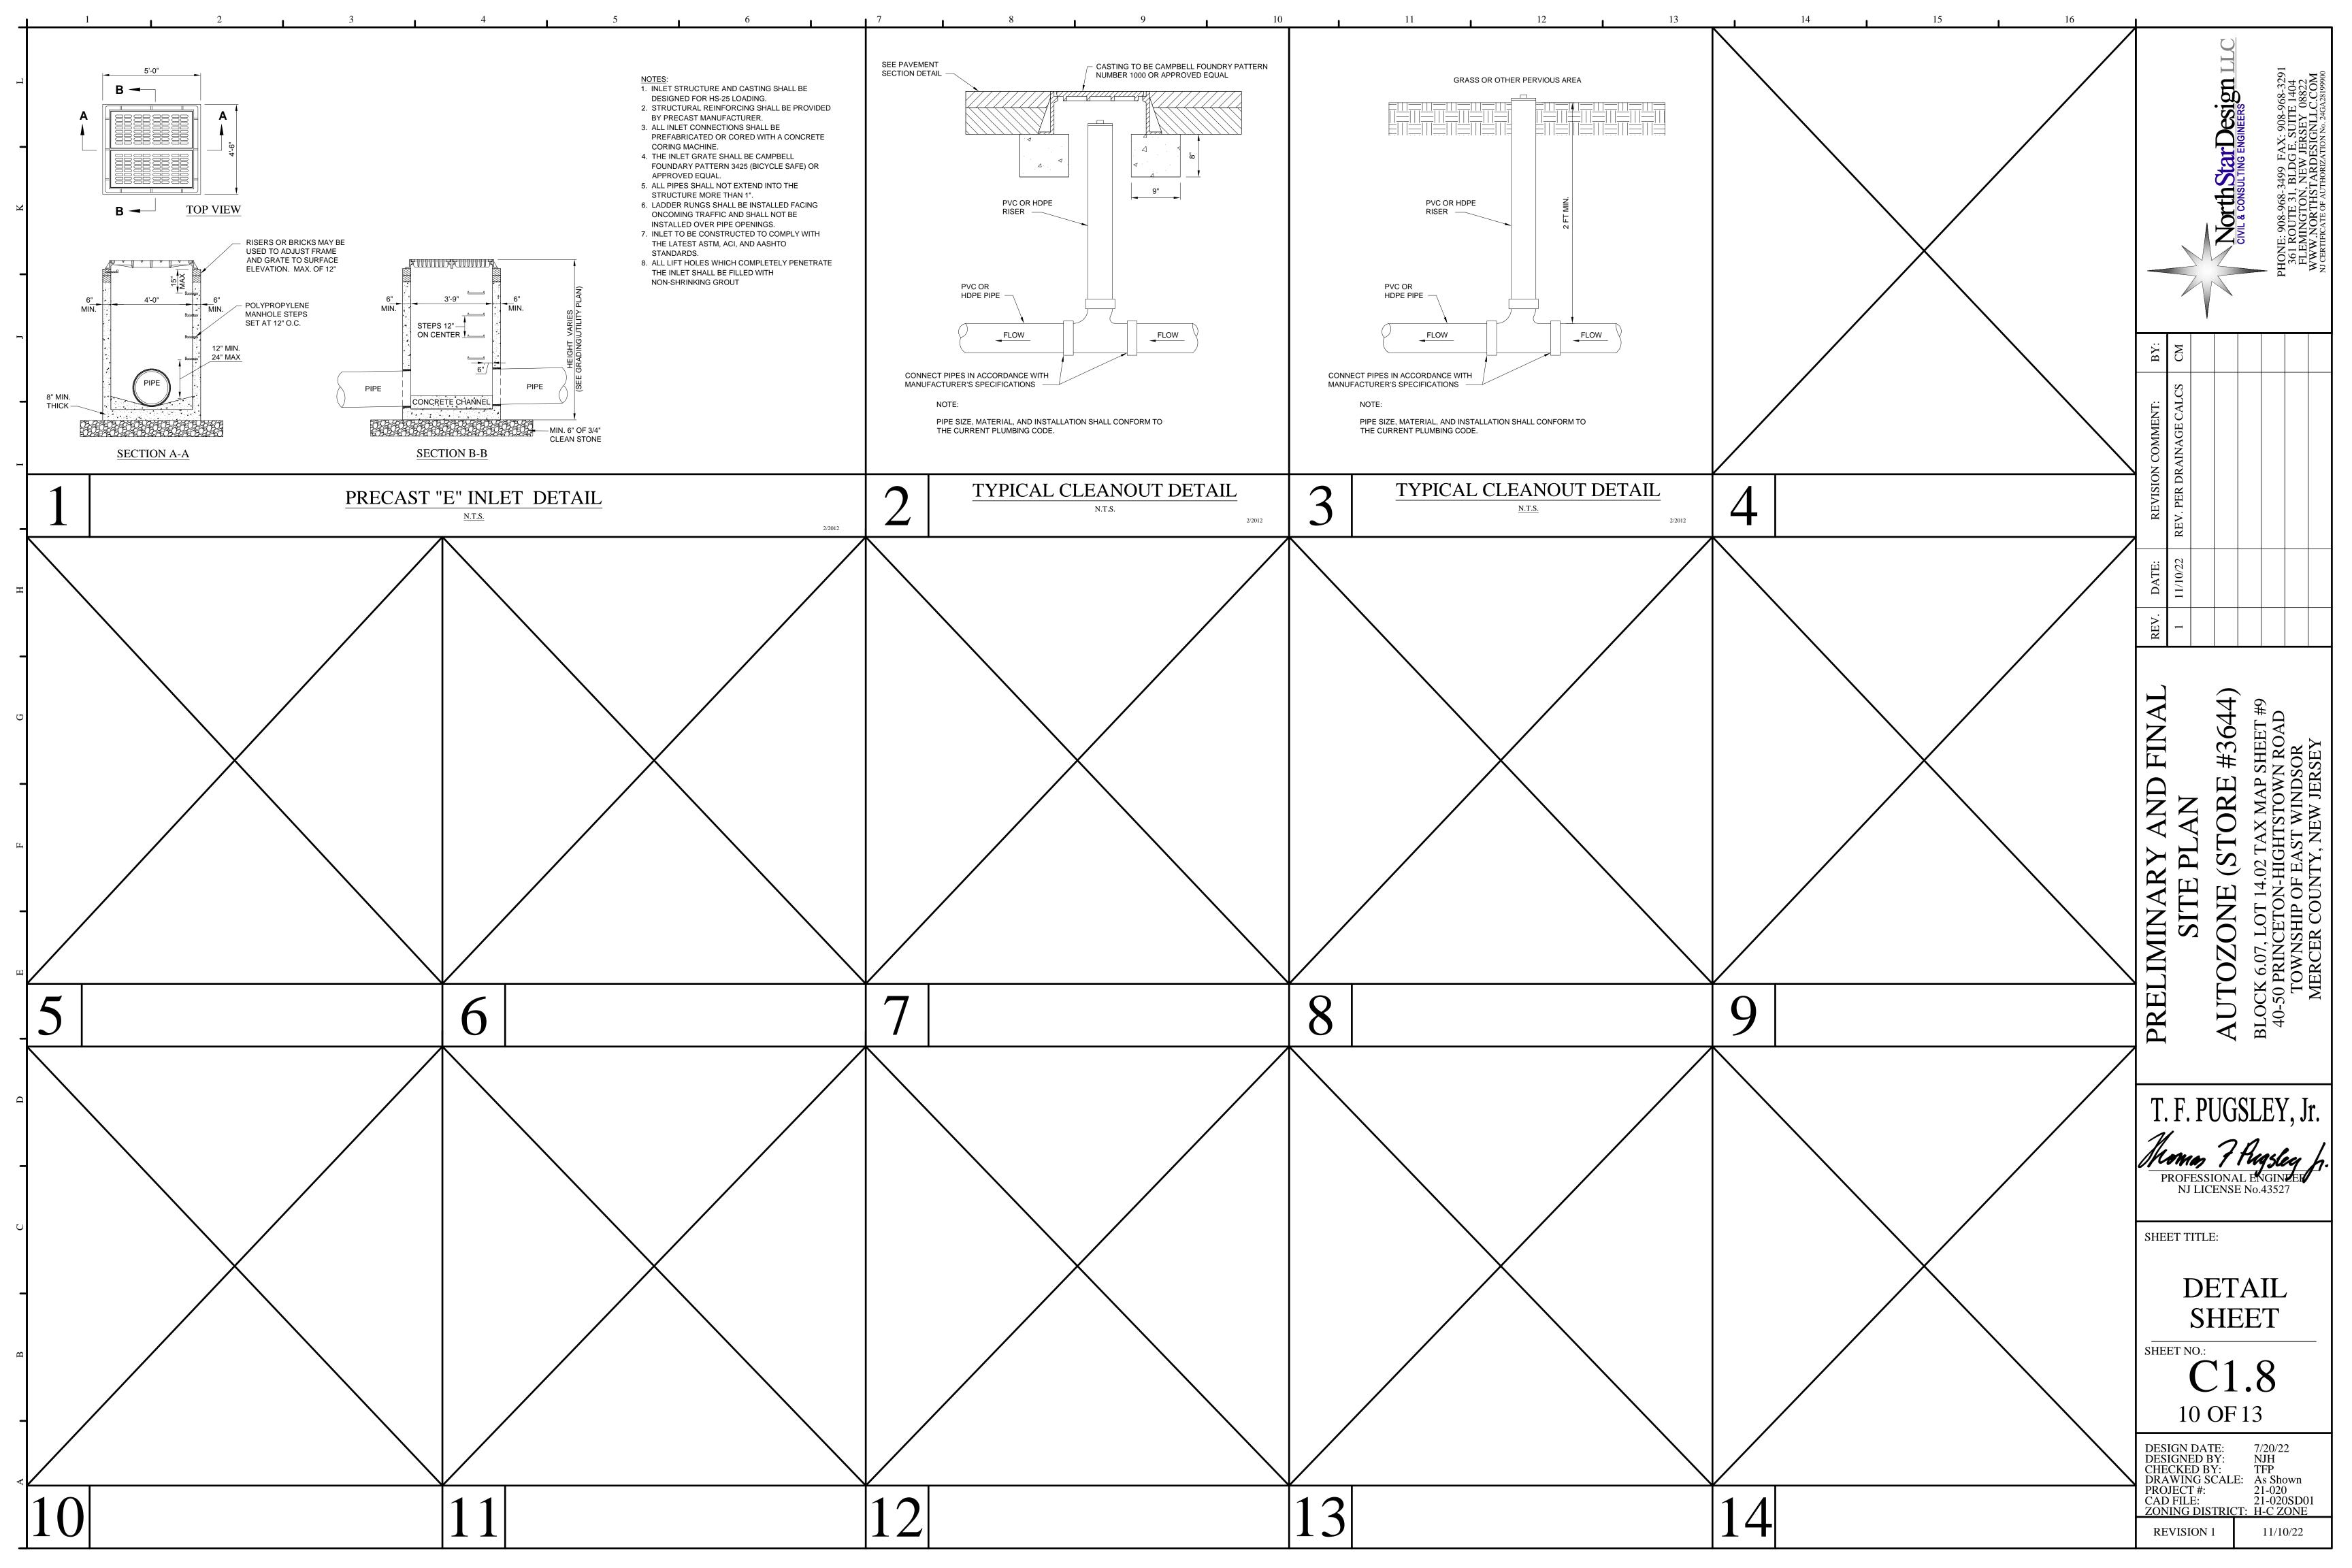

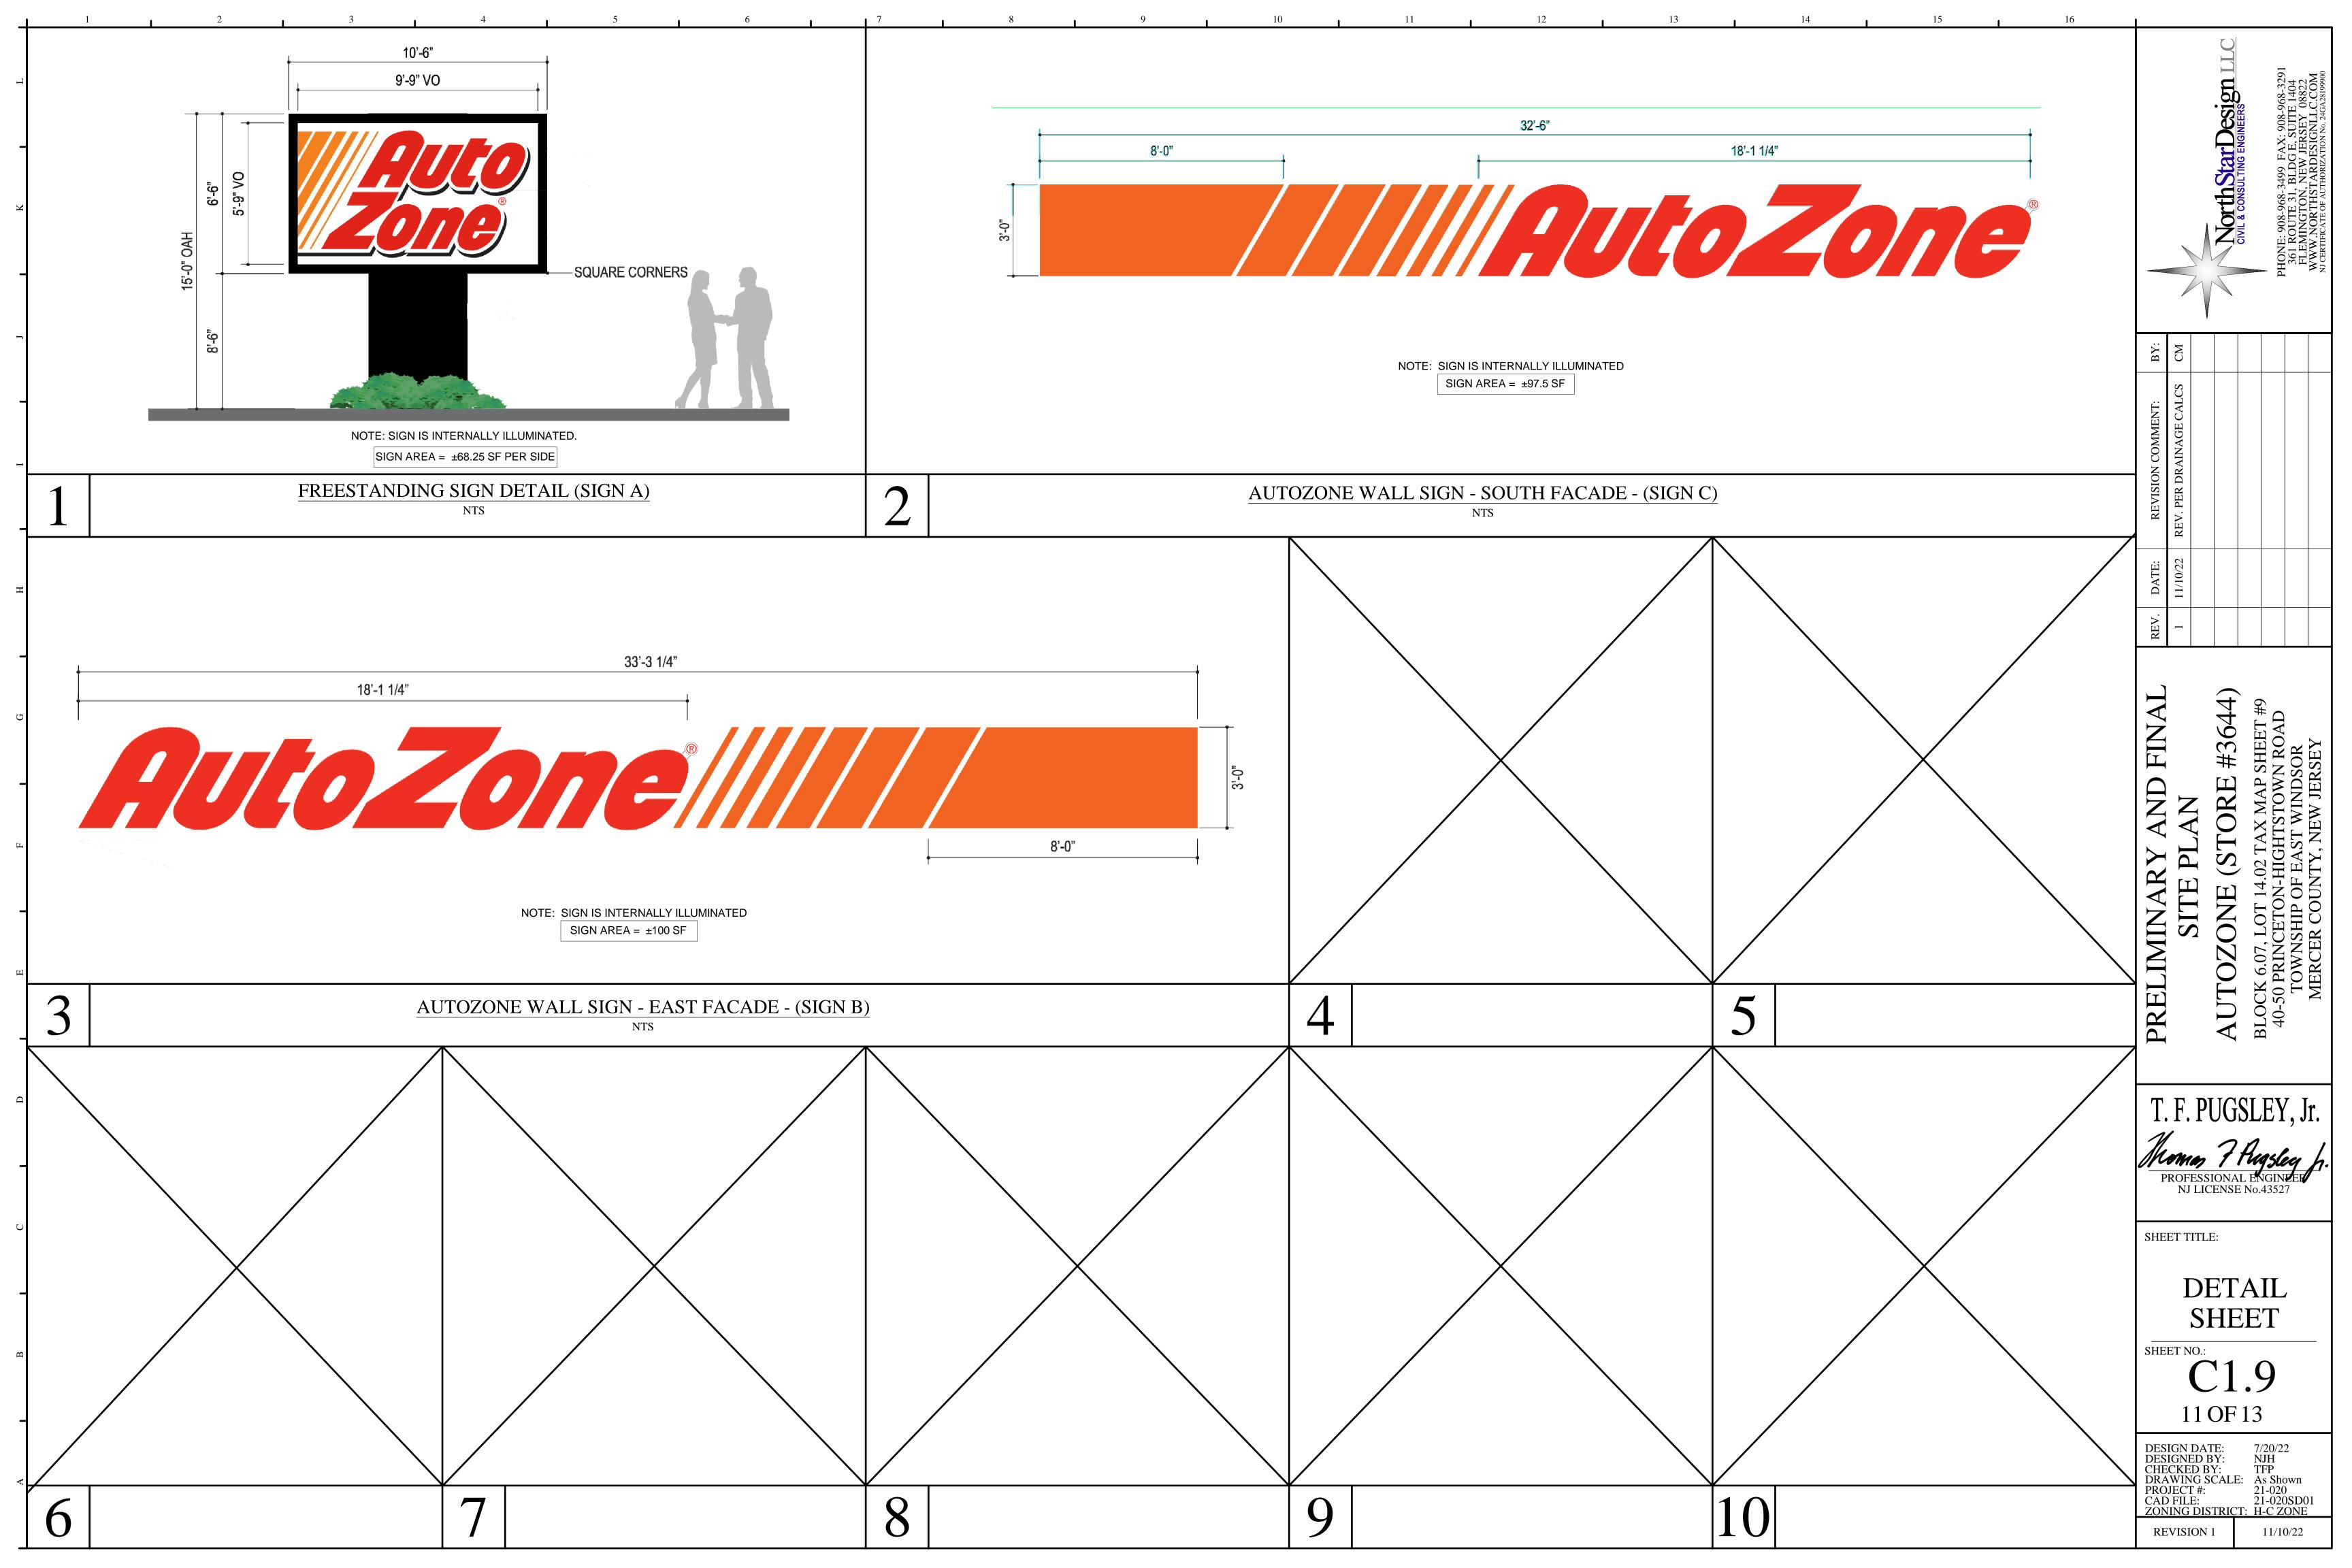

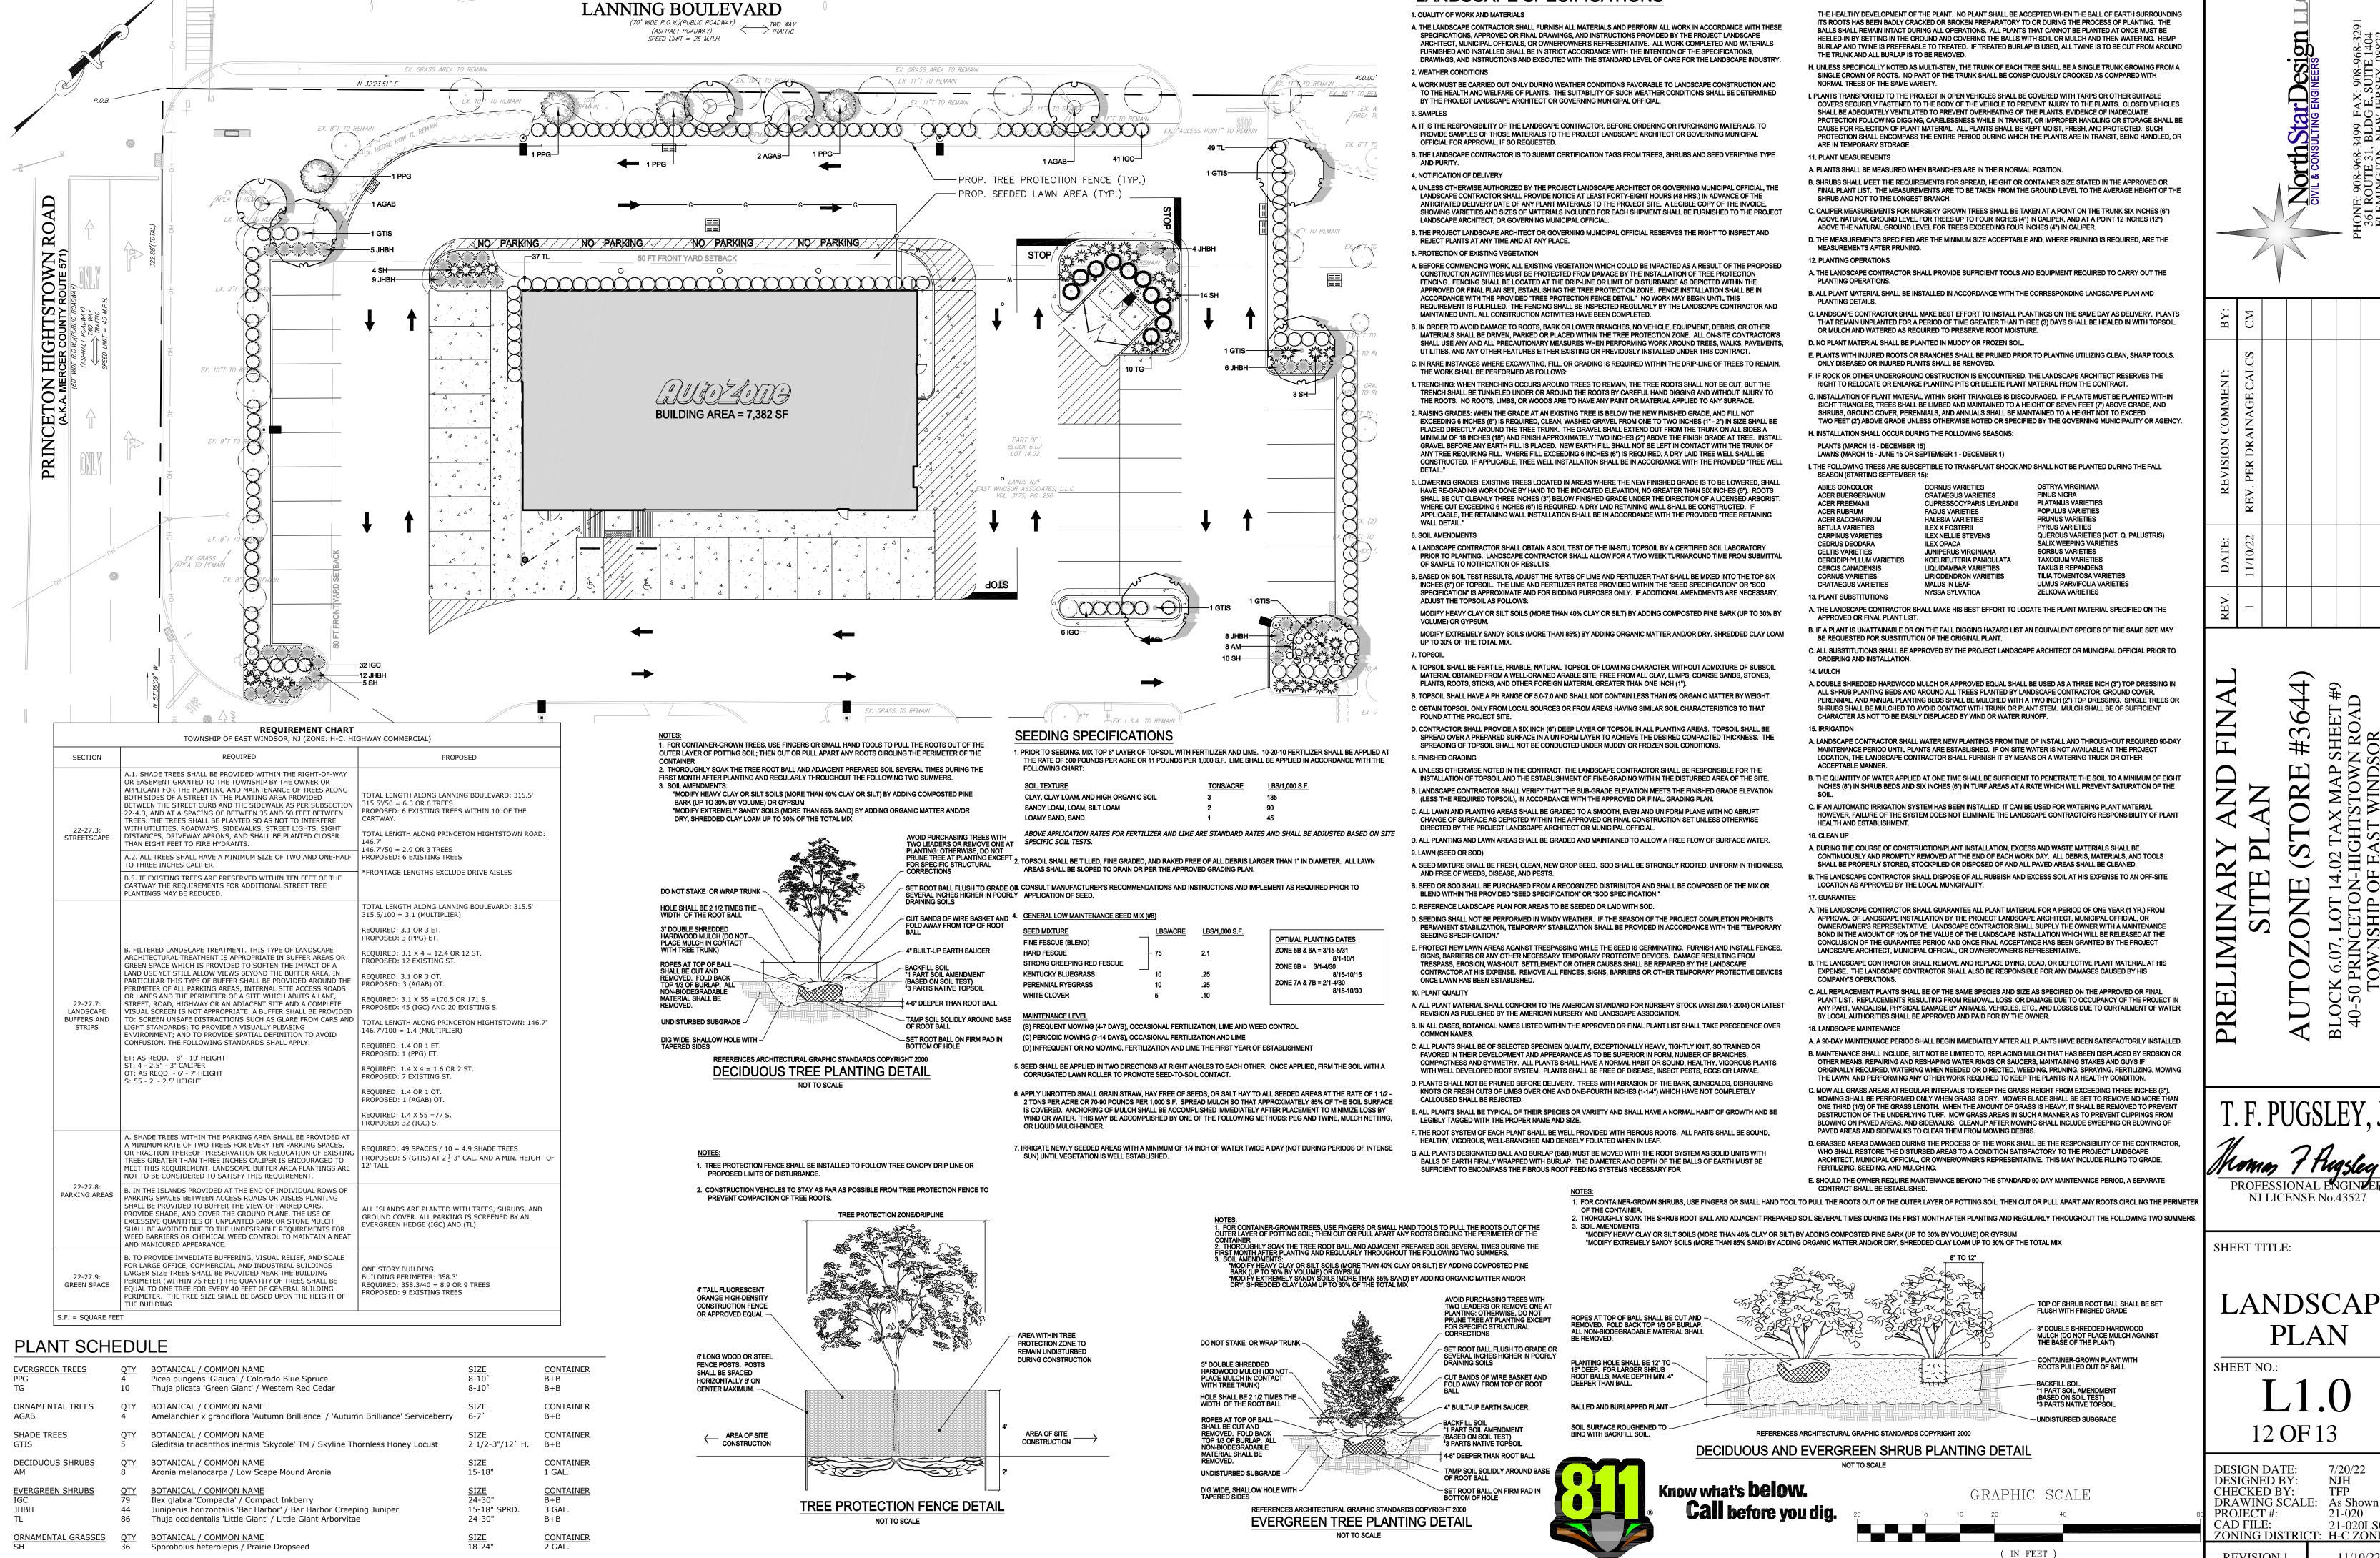

LANDSCAPE SPECIFICATIONS

CONE: 908-968-3499 FAX: 908-968-32361 ROUTE 31, BLDG E, SUITE 1404 FLEMINGTON, NEW JERSEY 08822 WW.NORTHSTARDESIGNLLC.CONTENTION OF A STANDING OF A STANDING

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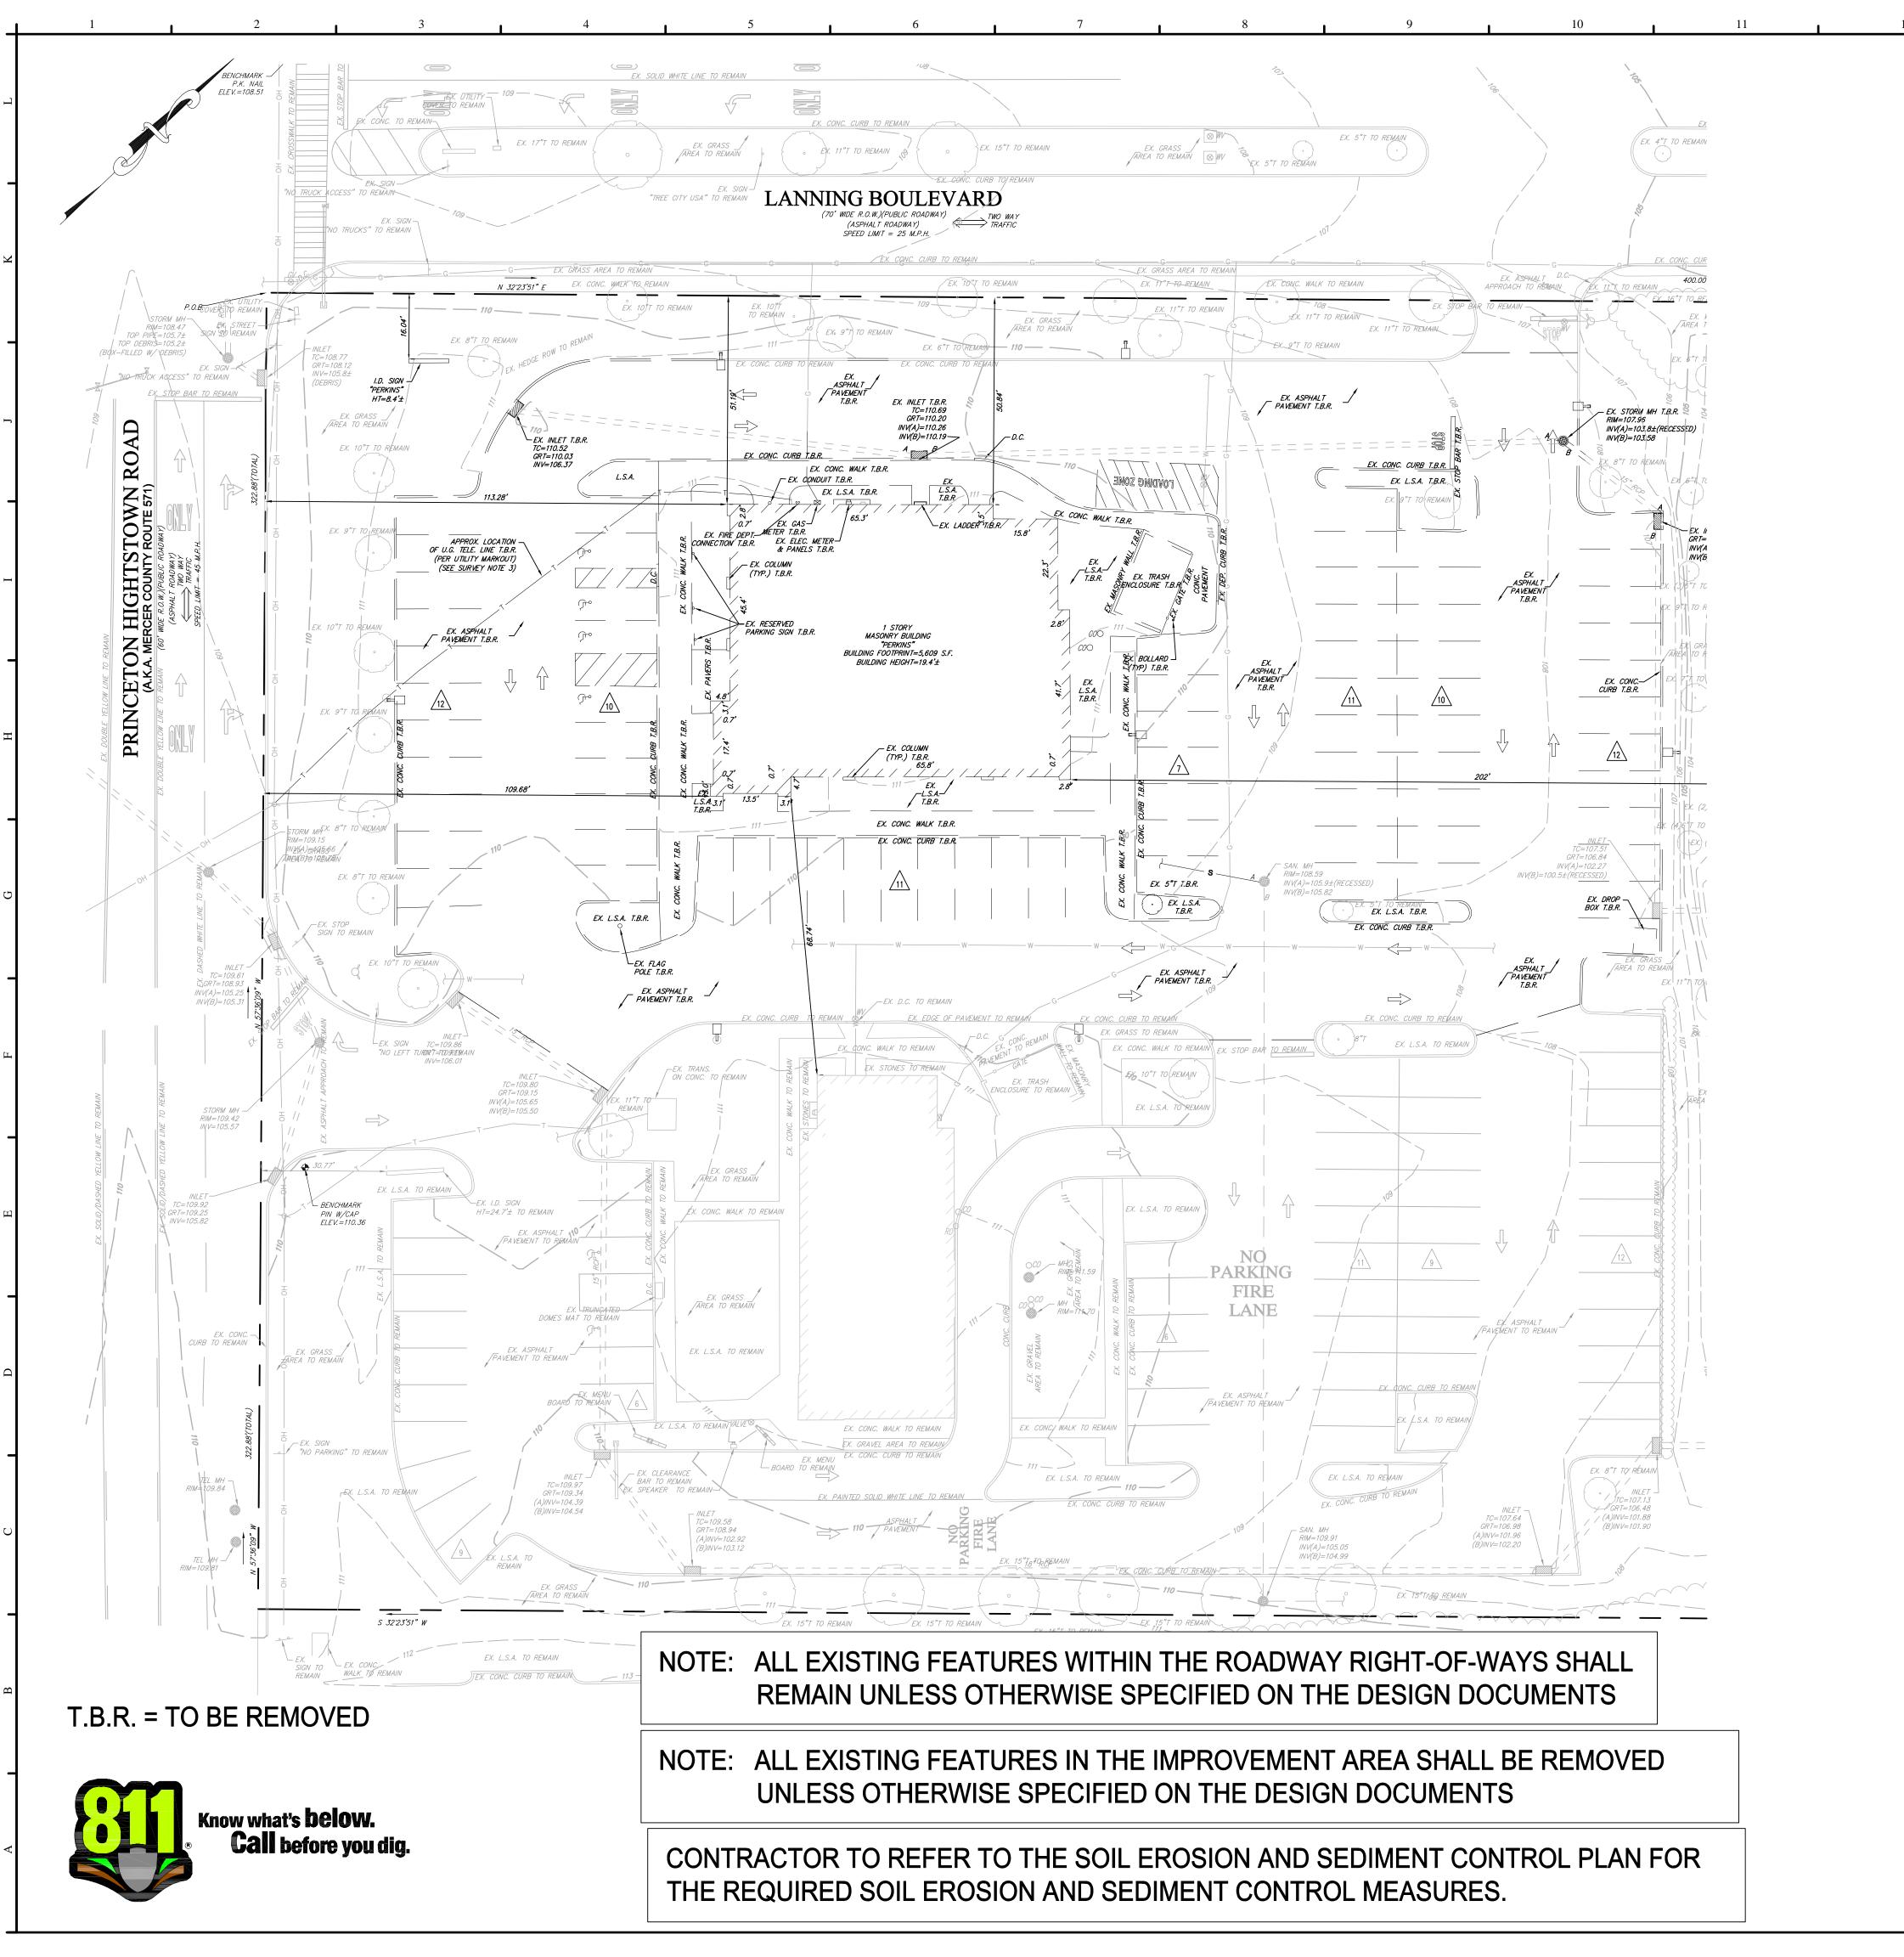
LANDSCAPE

TFP 21-020 21-020LS01 H-C ZONE

**REVISION** 

1 inch = 20 ft.

11/10/22



#### **DEMOLITION NOTES:**

- 1. ALL DEMOLITION ACTIVITIES ARE TO BE PERFORMED IN STRICT ADHERENCE TO ALL FEDERAL, STATE, AND LOCAL REGULATIONS.
- THIS DEMOLITION PLAN IS TO IDENTIFY WHAT ITEMS ARE TO REMAIN AND TO BE REMOVED. CONTRACTOR IS RESPONSIBLE FOR DETERMINING THE "MEANS AND METHODS" TO PERFORM THE WORK. WITHIN THE SUBJECT PROPERTY, THE INTENT IS TO HAVE A CLEAN, CLEAR SITE, FREE OF ALL EXISTING ITEMS NOTED TO BE REMOVED IN ORDER TO PERMIT THE CONSTRUCTION OF THE NEW PROJECT.
- PRIOR TO COMMENCING CONSTRUCTION, THE CONTRACTOR IS RESPONSIBLE FOR THE FOLLOWING:
  - A. OBTAIN ALL REQUIRED PERMITS AND PROVIDE A COPY ON SITE DURING
  - CONSTRUCTION. B. INSTALL ALL SOIL EROSION MEASURES AND NOTIFY THE LOCAL SOIL CONSERVATION DISTRICT A MINIMUM OF 72 HOURS IN ADVANCE TO START OF
  - CONSTRUCTION. C. CONTACT "ONE-CALL" UTILITY LOCATING SERVICES AT 811 OR 1-800-272-1000.

UTILITY SERVICES PROVIDED BY THE CONTRACTOR SHALL BE PERFORMED IN

- NO EXCAVATION SHALL BE PERFORMED WITHOUT A UTILITY MARKOUT. D. COORDINATE WITH THE UTILITY PROVIDERS TO ARRANGE SERVICE SHUT-OFFS RECONNECTION AND INSTALLATION OF NEW SERVICES. ANY
- ACCORDANCE WITH THE UTILITY COMPANIES REQUIREMENTS. E. IDENTIFY EXISTING ABOVE OR UNDERGROUND UTILITY INFRASTRUCTURE OR OTHER SURFACE FEATURES THAT ARE TO REMAIN AND PROVIDE ADEQUATE PROTECTION OF SAME. ANY DAMAGES TO ITEMS NOT IDENTIFIED ON THE DESIGN DRAWINGS AS TO BE REMOVED WILL BE REPAIRED TO EQUAL OR BETTER CONDITION THAT IT WAS ORIGINALLY AT THE SOLE COST OF THE
- CONTRACTOR. F. OBTAIN AND REVIEW ANY GEOTECHNICAL OR OTHER RELEVANT DESIGN DOCUMENTS AND FOLLOWING ANY GUIDELINES PROVIDED IN SAME.
- G. DOCUMENT THE EXISTING CONDITIONS ON-SITE AND ON THE ADJACENT PROPERTIES AND ROADWAYS AND KEEP FOR YOUR RECORDS.
- CONTRACTOR IS RESPONSIBLE FOR COMPLYING WITH AND ENFORCING THE LATEST REQUIREMENTS OF THE OCCUPATIONAL SAFETY AND HEALTH ACT (OSHA) OF 1970 (29 U.S.C. 651 et seq.) AND THE NEW JERSEY UNDERGROUND FACILITY PROTECTION ACT (N.J.S.A. 48:2-73 et seg.).
- CONTRACTOR IS RESPONSIBLE FOR JOB SITE SAFETY AND SUPERVISION. NORTH STAR DESIGN, LLC AND/OR ITS SUBCONSULTANTS IS NOT RESPONSIBLE FOR PERFORMING THESE SERVICES.
- 6. PROCEED WITH DEMOLITION IN A SYSTEMATIC AND SAFE MANNER FOLLOWING ALL OSHA REQUIREMENTS.
- 7. CONTRACTOR TO MONITOR AND MAINTAIN THE INSTALLED SOIL EROSION CONTROL MEASURES ON A REGULAR BASIS. ANY DEFICIENCIES IDENTIFIED SHOULD BE IMMEDIATELY ADDRESSED. CONTRACTOR SHALL UTILIZE DUST CONTROL MEASURES TO MINIMIZE AIRBORNE DUST IN ACCORDANCE WITH FEDERAL, STATE, AND LOCAL
- 8. CONTRACTOR SHALL PROVIDE ALL "MEANS AND METHODS" NECESSARY TO PREVENT MOVEMENT, SETTLEMENT, OR COLLAPSE OF EXISTING STRUCTURES TO REMAIN ON-SITE AND ON ADJACENT PROPERTIES. ANY DAMAGE AND REPAIR THAT MAY OCCUR TO THESE STRUCTURES IS THE SOLE RESPONSIBILITY OF THE CONTRACTOR
- EXPLOSIVES SHALL NOT BE USED WITHOUT OBTAINING PRIOR WRITTEN CONSENT OF BOTH THE PROPERTY OWNER AND ALL APPLICABLE GOVERNMENTAL AUTHORITIES. ALL REQUIRED FEDERAL, STATE, AND LOCAL PERMITS MUST BE OBTAINED PRIOR TO COMMENCEMENT OF AN EXPLOSIVE PROGRAM. THE CONTRACTOR IS ALSO RESPONSIBLE FOR ALL INSPECTION AND VIBRATING TESTING THAT IS REQUIRED TO MONITOR THE AFFECTS ON THE SURROUNDING PROPERTIES.
- 10. CONTRACTOR SHALL BACKFILL ALL EXCAVATIONS RESULTING FROM THE DEMOLITION PROCESS UTILIZING APPROVED BACKFILL MATERIALS AND SHALL BE SUFFICIENTLY COMPACTED TO SUPPORT NEW OR FUTURE IMPROVEMENTS. ALL EXCAVATIONS SHALL BE BACKFILLED IN ACCORDANCE WITH THE PROJECT GEOTECHNICAL REPORT (IF AVAILABLE).
- CONTRACTOR IS RESPONSIBLE FOR ALL TRAFFIC CONTROL PLANS AND MEASURES REQUIRED TO PERFORM THE PROPOSED IMPROVEMENTS. THIS INCLUDES SIGNAGE FLAGMEN, USE OF LOCAL POLICE OFFICERS, BARRIERS, CONES, CRASH TRUCKS, ETC. ALL MEASURES SHOULD COMPLY WITH THE LATEST EDITION OF THE MANUAL ON UNIFORM TRAFFIC CONTROL DEVICES, THE DEPARTMENT OF TRANSPORTATION DESIGN STANDARDS, AND/OR ANY LOCAL REQUIREMENTS.
- 12. NO CONSTRUCTION DEBRIS SHALL BE BURIED ON SITE. ALL CONSTRUCTION DEBRIS SHALL BE REMOVED FROM THE PROJECT SITE AND DISPOSED OF IN AN APPROVED FACILITY IN ACCORDANCE WITH FEDERAL, STATE, AND LOCAL REGULATIONS. RECORDS OF ALL DISPOSAL LOCATIONS SHALL MAINTAINED BY THE CONTRACTOR AND SHALL BE PROVIDED TO THE PROPERTY OWNER, DESIGN ENGINEER, OR OTHER AGENCY UPON REQUEST.
- EQUIPMENT, MATERIALS, AND SPOILS SHALL BE REMOVED FROM THE PROJECT SITE UNLESS WRITTEN APPROVAL HAS BEEN PROVIDED BY THE PROPERTY OWNER AND
- PERIMETER OF THE SUBJECT SITE FOR THE LENGTH OF THE PROJECT TO PROTEC

- ELEMENTS, BUT ALL UNDERGROUND ELEMENTS AS WELL INCLUDING BUT NOT

North Star Design

10NE: 908-968-3499 FAX: 908-968-329 361 ROUTE 31, BLDG E, SUITE 1404 FLEMINGTON, NEW JERSEY 08822 WWW.NORTHSTARDESIGNILC.CONTERTIFICATE OF AUTHORIZATION NO. 24GA2819990

T. F. PUGSLEY, Jr.

SHEET TITLE:

**PRELIMINAR** 

**DEMOLITION PLAN** 

D1.0 13 OF 13

21-020 21-020SS01

H-C ZONE

DESIGN DATE: 7/20/22
DESIGNED BY: NJH
CHECKED BY: TFP
DRAWING SCALE: As Shown

PROJECT #: CAD FILE: ZONING DISTRIC

**REVISION 1** 11/10/22

( IN FEET ) 1 inch = 20 ft.

GRAPHIC SCALE